JENSEN BLOCK EXTERIOR STAIRS AND DECKS

601 EASTLAKE AVE E, SEATTLE WA 98109

					<u> </u>	AO I LAILL AVI	<u> </u>
	ABBREVIATIONS					GRAPHIC SYMBOLS	
A AA AB	ATTIC ACCESS ANCHORBOLT	G GA GALV	GAGE GALVANIZED	R R R&S	RISER ROD & SHELF	LARGE SCALE SECTIONS	MATERIAL
ABV ACC	ABOVE ACCESSIBLE	GAR GB	GARAGE GRAB BAR	RAD RC	RADIUS RESILIENT CHANNEL	VII I I I I I I I I I I I I I I I I I I	FINISHED
ACOUS ADA ADDL	ACOUSTICAL AMERICANS WITH DISABILITIES ACT ADDITIONAL	GENL GL GLU LAM	GENERAL GLASS GLUE LAMINATED	RCP RD REF	REFLECTED CEILING PLAN ROOF DRAIN REFER (ENCE), REFRIGERATOR		WOOD
ADJ AFF	ADJUSTABLE ABOVE FINISH FLOOR	GOVT GYP	GOVERNMENT GYPSUM	REINF REQD	REINFORCE (Ď), (ING) REQUIRED		CONTINUOUS ROUGH FRAMING
AL ALT APPROX	ALUMINUM ALTERNATE APPROXIMATE	GWB	GYPSUM WALL BOARD	RESID RESIL REV	RESIDENTIAL RESILIENT REVISION (S), REVISED		BLOCKING
APT ARCH AVE	APARTMENT ARCHITECT (URAL) AVENUE	Н Н НВ НС	HIGH HOSE BIBB HANDICAPPED	RFG RM RO ROW	ROOFING ROOM ROUGH OPENING RIGHT OF WAY		PLYWOOD
B BD	BOARD	HDWD HDWE HGT	HARDWOOD HARDWARE HEIGHT	S			CONCRETE CAST-IN-PLACE
BIBS BITUM	BLOWN IN BATT SYSTEM BITUMINOUS	HM HORIZ	HOLLOW METAL HORIZONTAL	S S	SINK SOUTH		
BLDG BLKG BLVD	BUILDING BLOCKING BOULEVARD	HP HR	HYDROPANEL FOR GAS, HOTWATER FAN COIL UNIT HOUR	SAT SBC SCHED	SUSPENDED ACOUSTICAL TILE SEATTLE BUILDING CODE SCHEDULE		GRANULAR FILL
BM BO	BEAM BOTTOM OF	HTR HVAC	HEATER HEATING, VENTILATION,	SD SF	STORM DRAIN SQUARE FOOT		EARTH
BOT BR BSMT	BOTTOM BEDROOM BASEMENT		AND AIR CONDITIONING	SHF SHT SHTG	SHELF SHEET SHEATHING		GLASS
BUR	BUILT UP ROOF	I IBC	INTERNATIONAL BUILDING CODE	SHV SI	SHELVES (ING) SQUARE INCH		<u></u>
C CAB	CABINET	ID IIC INCL	INSIDE DIAMETER IMPACT INSULATION CLASS INCLUDING	SIM SP SPEC	SIMILAR STANDPIPE SPECIFICATION		RIGID INSULATION
CALC CB	CALCULATION CATCH BASIN	INCL INSUL INT	INSULATION INTERIOR	SPEC SPKLR SQ	SPRINKLER SQUARE		BATT INSULATION
CER CIP	CERAMIC TILE CAST-IN-PLACE (CONCRETE) CENTERLINE	IRC	INTERNATIONAL RESIDENTIAL CODE	SS ST ST	SANITARY SEWERS STAINLESS STEEL STREET		
CL CLG CLR	CEILING CLEAR	K KIT	KITCHEN	STC STOR	SOUND TRANSMISSION CLASS STORAGE		GWB
CMU CO COL	CONCRETE MASONRY UNIT CLEAN OUT COLUMN	ı		STRUCT SUSP SYS	STRUCTURE SUSPENDED SYSTEM		
CONC CONT	CONCRETE CONTINUOUS	L L LAM	LEFT, LONG LAMINATE(D)	313	STOTEM	∠ DRAWIN	G NUMBER
CONTR COORD CORR	CONTRACT (OR) COORDINATE CORRIDOR	LAU LAV LB	LAUNDRY LAVATORY POUND	T T T&G	TREAD TONGUE AND GROOVE	SIM	DETAIL SECTION
CPT CSMT	CARPET (ED) CASEMENT	LNDRY LOC	LAUNDRY LOCATION	TB TEL	TOWEL BAR - 24" UNO TELEPHONE	A101 SHEET N	
СТ	CARPET TILE	LR LRG LT	LIVING ROOM LARGE LIGHT	TEMP THK THRU	TEMPORARY THICK (NESS) THROUGH		
D D	DRYER, DEEP	LTG	LIGHTING	TOB TOC	TOP OF BEAM TOP OF CURB	SIM	G NUMBER BUILDING SECTION
DEMO DEPT DET	DEMOLISH, DEMOLITION DEPARTMENT DETAIL	M MAS	MASONRY	TOD TOFF TOT	TOP OF DRAIN TOP OF FINISH FLOOR TOTAL	A101	
DF DIAM	DRINKING FOUNTAIN DIAMETER	MATL MAX MBR	MATERIAL MAXIMUM MASTER BEDROOM	TOW TR TV	TOP OF WALL TOWEL RING	SHEET N	
DIM DN DO	DIMENSION DOWN DITTO	MECH MC	MASTER BEDROOM MECHANICAL MEDICINE CABINET	TYP	TELEVISION TYPICAL	VIEW — DRAWIN	G NUMBER BUILDING ELEVATION
DR DS DW	DINING ROOM, DOOR DOWNSPOUT DISHWASHER	MEMB MET MEZZ	MEMBRANE METAL MEZZANINE	U UBC	UNIFORM BUILDING CODE	A 1 A101	OR INTERIOR ELEVATION
DWG DWR	DRAWING DRAWER	MFR MIN	MANUFACTURE (R) MINIMUM, MINUTE	UNFIN UNO	UNFINISHED UNLESS NOTED OTHERWISE	SHEET N	NUMBER
E		MISC MO MULT	MISCELLANEOUS MASONRY OPENING MULTIPLE	UTIL	UTILITY		ELEVATION POINT OR
E EA	EAST EACH			V VB	VAPOR BARRIER		CONTROL POINT
EIFS EL	EXTERIOR INSULATION AND FINISH SYSTEM ELEVATION	N N NA	NORTH NOT APPLICABLE	VCT VEH VERT	VINYL COMPOSITION TILE VEHICLE VERTICAL	1	REVISION
ELEC ELEV	ELECTRIC (AL) ELEVATOR	NIC NO	NOT IN CONTRACT NUMBER	VIF VIN	VERIFY IN FIELD VINYL	VCPT	FLOOR TRANSITION
ENCL EP EQ	ENCLOSE (URE) ELECTRICAL PANEL EQUAL	NOM NTS	NOMINAL NOT TO SCALE	VT	VINYL TILE	•	PROPERTY CORNER
EQUIP ESMT	EQUIPMENT EASEMENT	0	ON OFNITED	W W	WEST, WIDE, WASHER		TEMPERED/SAFETY
EST EW EXH	ESTIMATE (D) EACH WAY EXHAUST	OC OD OFI	ON CENTER OUTSIDE DIAMETER OWNER FURNISHED & INSTALLED	W/ W/D W/O	WITH WASHER / DRYER WITHOUT		GLAZING
EXP EXST	EXPANSION EXISTING	OFF OPNG	OFFICE OPENING	WAC	WASHINGTON ACCESSIBILITY CODE		SITE POLE LIGHT
EXT F	EXTERIOR	OPP ORD OVHD	OPPOSITE OVERFLOW ROOF DRAIN OVERHEAD	WC WD WDW	WATER CLOSET WOOD WINDOW	SLOPE 4/1 <u>2</u>	DOOF OLODE
FAC FAM	FACTORY FLUID APPLIED MEMBRANE	D		WH WRB	DOMESTIC WATER HEATER TANK WATER RESISTIVE BARRIER		ROOF SLOPE
FCIO FD	FURNISHED BY CONTRACTOR; INSTALLED BY OWNER FLOOR DRAIN	P P PED	PANTRY PEDESTAL			S	SMOKE DETECTOR
FDN FE FEP	FOUNDATION FIRE EXTINGUISHER FINISHED END PANEL	PERF PERIM PERM	PERFORATED PERIMETER PERMANENT			TYP 1i	WALL TYPE
FIN FL	FINISH (ED) FLASHING	PERP PL	PERPENDICULAR PROPERTY LINE				
FLR FOC FOF	FLOOR FACE OF CONCRETE FACE OF FINISH	PLAM PLWD PR	PLASTIC LAMINATE PLYWOOD PAIR			X-XX	WINDOW TAG
FOM FOS	FACE OF MASONRY FACE OF STUDS	PRCST PREFAB	PRECAST PREFABRICATED			(X-XXX)	DOOR TAG
FOIA FOIC	FURNISHED BY OWNER; INSTALLED BY ARTIST FURNISHED BY OWNER;	PRELIM PRKG PROJ	PRELIMINARY PARKING PROJECT				- ···-
FPL	INSTALLED BY CONTRACTOR FIREPLACE	PROP PSI	PROPERTY POUNDS PER SQUARE INCH				
FRT FT FTG	FIRE RETARDANT TREATED FOOT, FEET FOOTING	PT PTD PVMT	POST-TENSIONED, PRESSURE TREATED PAINTED PAVEMENT			SEE DRAWINGS FOR ADDITIONAL SYM	IBOL LEGENDS.
FIG FURN	FURNITURE, FURNISHE(D)	r v IVI I					

PROJECT DESCRIPTION

REPLACE EXTERIOR EXIT STAIRS AND DECKS ON THE REAR ELEVATION OF A HISTORIC BUILDING. REPLACEMENT IS NECESSARY DUE TO POOR CONDITION OF CURRENT STRUCTURE DUE TO ROT AND WATER DAMAGE

PROJECT INFORMATION

PROPERTY LOCATION: 601 EASTLAKE AVE E, SEATTLE WA

PARCEL NUMBER: 292504-9097 TOTAL PROPERTY SIZE: 0.34 ACRES

CURRENT ZONING: SM-SLU 100/95 URBAN VILLAGE: SOUTH LAKE UNION URBAN CENTER "PARKING FLEXIBILITY AREA"

SEATTLE LANDMARK: 76/95

APPLICABLE BUILDING AND ZONING CODES: SEATTLE MUNICIPAL CODE, 2015 SEATTLE BUILDING CODE, 2015 SEATTLE EXISTING BUILDNG CODE, ICC A117.1-2009

BUILDING OCCUPANCY BY USE: B AND R-2 CONSTRUCTION TYPE: V-A

FIRE SPRINKLER: FULLY SPRINKLERED PER 1997 BUILDING PERMIT DRAWINGS AND HAS SIDE WALL SPRINKLERS ALONG THE EXTERIOR DECKS AND STAIRS

BUILDING FOOTPRINT (WITHOUT DECKS): 7,546 SF PROPOSED DECK FOOTPRINT:

GROSS BUILDING AREAS

BASEMEI	NT (MIXED OCCUPANCY):	7,546 SF
FIRST FL	OOR (B OCCUPANCY):	7,546 SF
SECOND	FLOOR (R-2 OCCUPANCY):	7,207 SF
THIRD FL	OOR (R-2 OCCUPANCY):	7,207 SF
TOTAL GROSS	FLOOR AREA:	29,506 SI
-	·	

PROPOSED DECK AREAS

913 - 1,068 SF FIRST FLOOR SECOND FLOOR 565 - 1010 SF THIRD FLOOR 562 - 1012 SF TOTAL DECK AREA: 2,040 - 3,090 SF

PROJECT TEAM

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email: brad.reuling@lihi.org

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> **ARCHITECT** TONKIN ARCHITECTURE 2701 1ST AVE SUITE 520 SEATTLE, WA 98121 PHONE: (206) 624-7880 CONTACT: PAMELA DERRY cell: (425) 445-2365 email: pam@tonkinarchitecture.com

COVER SHEET SITE PLAN HISTORIC EXTERIOR DECK & STAIR PLANS EXISTING PARKING & STAIRS BASEMENT PLAN EXISTING EXTERIOR DECK & STAIR PLANS EXISTING BASEMENT & FIRST FLOOR PLAN

SHEET INDEX

EXISTING SECOND & THIRD FLOOR PLAN PROPOSED PARKING & STAIRS BASEMENT PLAN PROPOSED EXTERIOR DECK & STAIRS WEST ELEVATION - HISTORIC & EXISTING

PERSPECTIVE VIEWS - HISTORIC AND EXISTING

WEST ELEVATION PROPOSED

PERSPECTIVE VIEWS - PROPOSED

JENSEN BLOCK SITE

VICINITY MAP

CODE NOTES

23.48.280 MAXIMUM PARKING IN SOUTH LAKE UNION URBAN CENTER: 1 PARKING SPACE PER 1000 SF OF GROSS NONRESIDENTIAL FLOOR AREA

23.54.015 TABLE A-II-J: NO REQUIRED PARKING FOR NON-RESIDENTIAL USES IN AN URBAN CENTER

23.54.015 TABLE B-II-L: NO REQUIRED PARKING FOR MULTIFAMILY RESIDENTIAL IN AN URBAN CENTER

23.54.030 - PARKING SPACE AND ACCESS STANDARDS

- A. 1. "LARGE VEHICLE" PARKING SPACE MEANS SPACE 8.5 FT IN WIDTH AND 19 FEET IN LENGTH
- 2. "MEDIUM VEHICLE" PARKING SPACE MEANS SPACE 8.0 FT IN WIDTH AND 16 FEET IN LENGTH "SMALL VEHICLE" PARKING SPACE MEANS SPACE 7.5 FT IN WIDTH AND 15 FEET IN LENGTH
- 'BARRIER-FREEPARKING" MEETS THE FOLLOWING STANDARDS:
- a. WIDTH NOT LESS THAN 8 FEET. ADACENT ACCESS AISLE MIN 5 FEET IN WIDTH. VAN SPACE ACCESS AISLE MIN 8 FEET CAN SHARE AISLE
- AT LEAST ONE BARRIER FREE SPACE 19 FEET IN LENGTH, OTHER LENGTH IN APPROX. PROPORTION TO THE NUMBER OF EACH SIZE SPACE PROVIDED ON THE LOT.
- B. 2b. NONRESIDENTIAL USES: WHEN BETWEEN 11 AND 19 PARKING SPACES ARE PROVIDED, A MIN OF 25% OF THE PARKING SPACES SHALL BE STRIPED FOR SMALL VEHICLES. A MAX OF 65 OF THE PARKING SPACES MAY BE STRIPED FOR SMALL VEHICLES. A MIN OF 35% OF THE SPACES SHALL BE STRIPED FOR LARGE VEHICLES.
- E. 1. PER TABLE: 90 DEGREE SPACES, 19 FT STALL: REQUIRED AISLE WIDTH = 24 FEET
- 2. MIN AISLE WIDTH SHALL BE PROVIDED FOR LARGEST VEHICLES SERVED BY THE AISLE

2015 SEATTLE EXISTING BUILDING CODE

- 503.1 SCOPE. LEVEL 1 ALTERATIONS INCLUDE THE REMOVAL AND REPLACEMENT OR THE COVERING OF EXISTING MATERIALS, ELEMENTS, EQUIPMENT, OR FIXTURES THAT SERVE THE SAME PURPOSE
- 503.2 LEVEL 1 ALTERATIONS SHALL COMPLY WITH THE PROVISIONS OF CHAPTER 7..
- 702.6 ALL NEW WORK SHALL COMPLY WITH THE MATERIALS AND METHODS REQUIREMENTS OF THE IBC AS APPLICABLE
- 703.1 ALTERATIONS SHALL BE DONE IN A MANNER THAT MAINTAINS THE LEVEL OF FIRE PROTECTION PROVIDED. 704.1 ALTERATIONS SHALL BE DONE IN A MANNER TAHT MAINTAINS THE LEVEL OF PROTECTION PROVIDED FOR THE MEANS OF EGRESS.
- 705.1 A FACILITY THAT IS ALTERED SHALL COMPLY WITH THE APPICABLE PROVISIONS OF SECTION 307.

2015 SEATTLE BUILDING CODE

- 1005.1 DOORS WHEN FULLY OPENED SHALL NOT REDUCE THE REQUIRED MEANS OF EGRESS WIDTH BY MORE THAN 7 INCHES. DOORS IN ANY POSITION SHALL NOT REUDCE TEH REQUIRED WIDTH BY
- 1008 MEANS OF EGRESS ILLUMINATION IS REQUIRED.
- 1017.4 THERE SHALL NOT BE ENCLOSED SPACE UNDER EXTERIOR EXIT STAIRWAYS UNLESS THE SPACE IS COMPLETELY ENCLOSED IN 1 HOUR FIRE RESISTANCE RATED CONSTRUCTION. THE OPEN SPACE UNDER EXTERIOR STAIRWAYS SHALL NOT BE USED FOR ANY PURPOSE
- 1011.8 A FLIGHT OF STAIRS SHALL NOT HAVE A VERTICAL RISE GREATER TAHN 12 FT BETWEEN FLOOR LEVELS OR LANDINGS.
- 1018.2 WITH AN OCCUPANT LOAD OF LESS THAN 50, THE MINIMUM CORRIDOR WIDTH IS 36"
- 1021.1 BALCONIES USED FOR EGRESS PURPOSES SHALL CONFIRM TO THE SAME REQUIREMENTS AS CORRIDORS FOR MINIMUM WIDTH, REQUIRED CAPACITY, HEADROOM, DEAD ENDS AND PROJECTIONS. 1021.1 EXTERIOR EGRESS BALCONIES SHALL BE SEPARATED FROM THE INTERIOR OF THE BUILDING BY WALLS AND OPENING PROTECTIVES AS REQUIRED FOR CORRIDORS
- EXCEPTION: SEPARATION IS NOT REQUIRED WHERE THE EXTERIOR EGRESS BALCONY IS SERVED BY NOT LESS THAN TWO STAIRWAYS AND A DEAD-END TRAVLE CONDITION DOES NOT REQUIRE TRAVEL PAST AN UNPROTECTED OPENING TO REACH A STAIRWAY. 1027.5 EXTERIOR EXIT STAIRWAYS SHALL HAVE A MINIMUM FIRE SEPARATION DISTANCE OF 10 FT FROM ADJACENT LOT LINES.
- 1027.6 EXTERIOR EXIT STAIRWAYS SHALL BE SEPARATED FROM THE INTERIOR OF THE BUILDING. OPENINGS SHALL BE LIMITED TO THOSE NECESSARY FOR EGRESS FROM NORMALLY OCCUPIED SPACES. EXCEPTION 3: SEPARATION NOT REQUIRED PROVIDED ITEMS 3.1 THROUGH 3.5 ARE MET:
 - 3.1 EQUIPPED WITH AN AUTOMATIC SPRINKLER SYSTEM IN ACCORDANCE WITH SECTION 903.2.1.1 OR 903.3.1.2
 - 3.2 THE OPEN ENDED CORRIDORS COMPLY WITH SECTION 1020.
 - 3.3 THE OPEN ENDED CORRIDORS ARE CONNECTED ON EACH END TO AN EXTERIOR EXIT STAIRWAY.
 - 3.4 THE EXTERIOR WALLS AND OPENINGS ADJACENT COMPLY WITH SECTIONS 1023.7 AND 1027.7 3.5 STAIRS AT CHANGE OF DIRECTION...

98109 APTS LLC E A, SEATTLE SEATTLE, JENSEN BLOCK A JACKSON, SUITE AVE

PRELIMINARY 11/30/2020 02/18/2021 LANDMARKS

DATE REV

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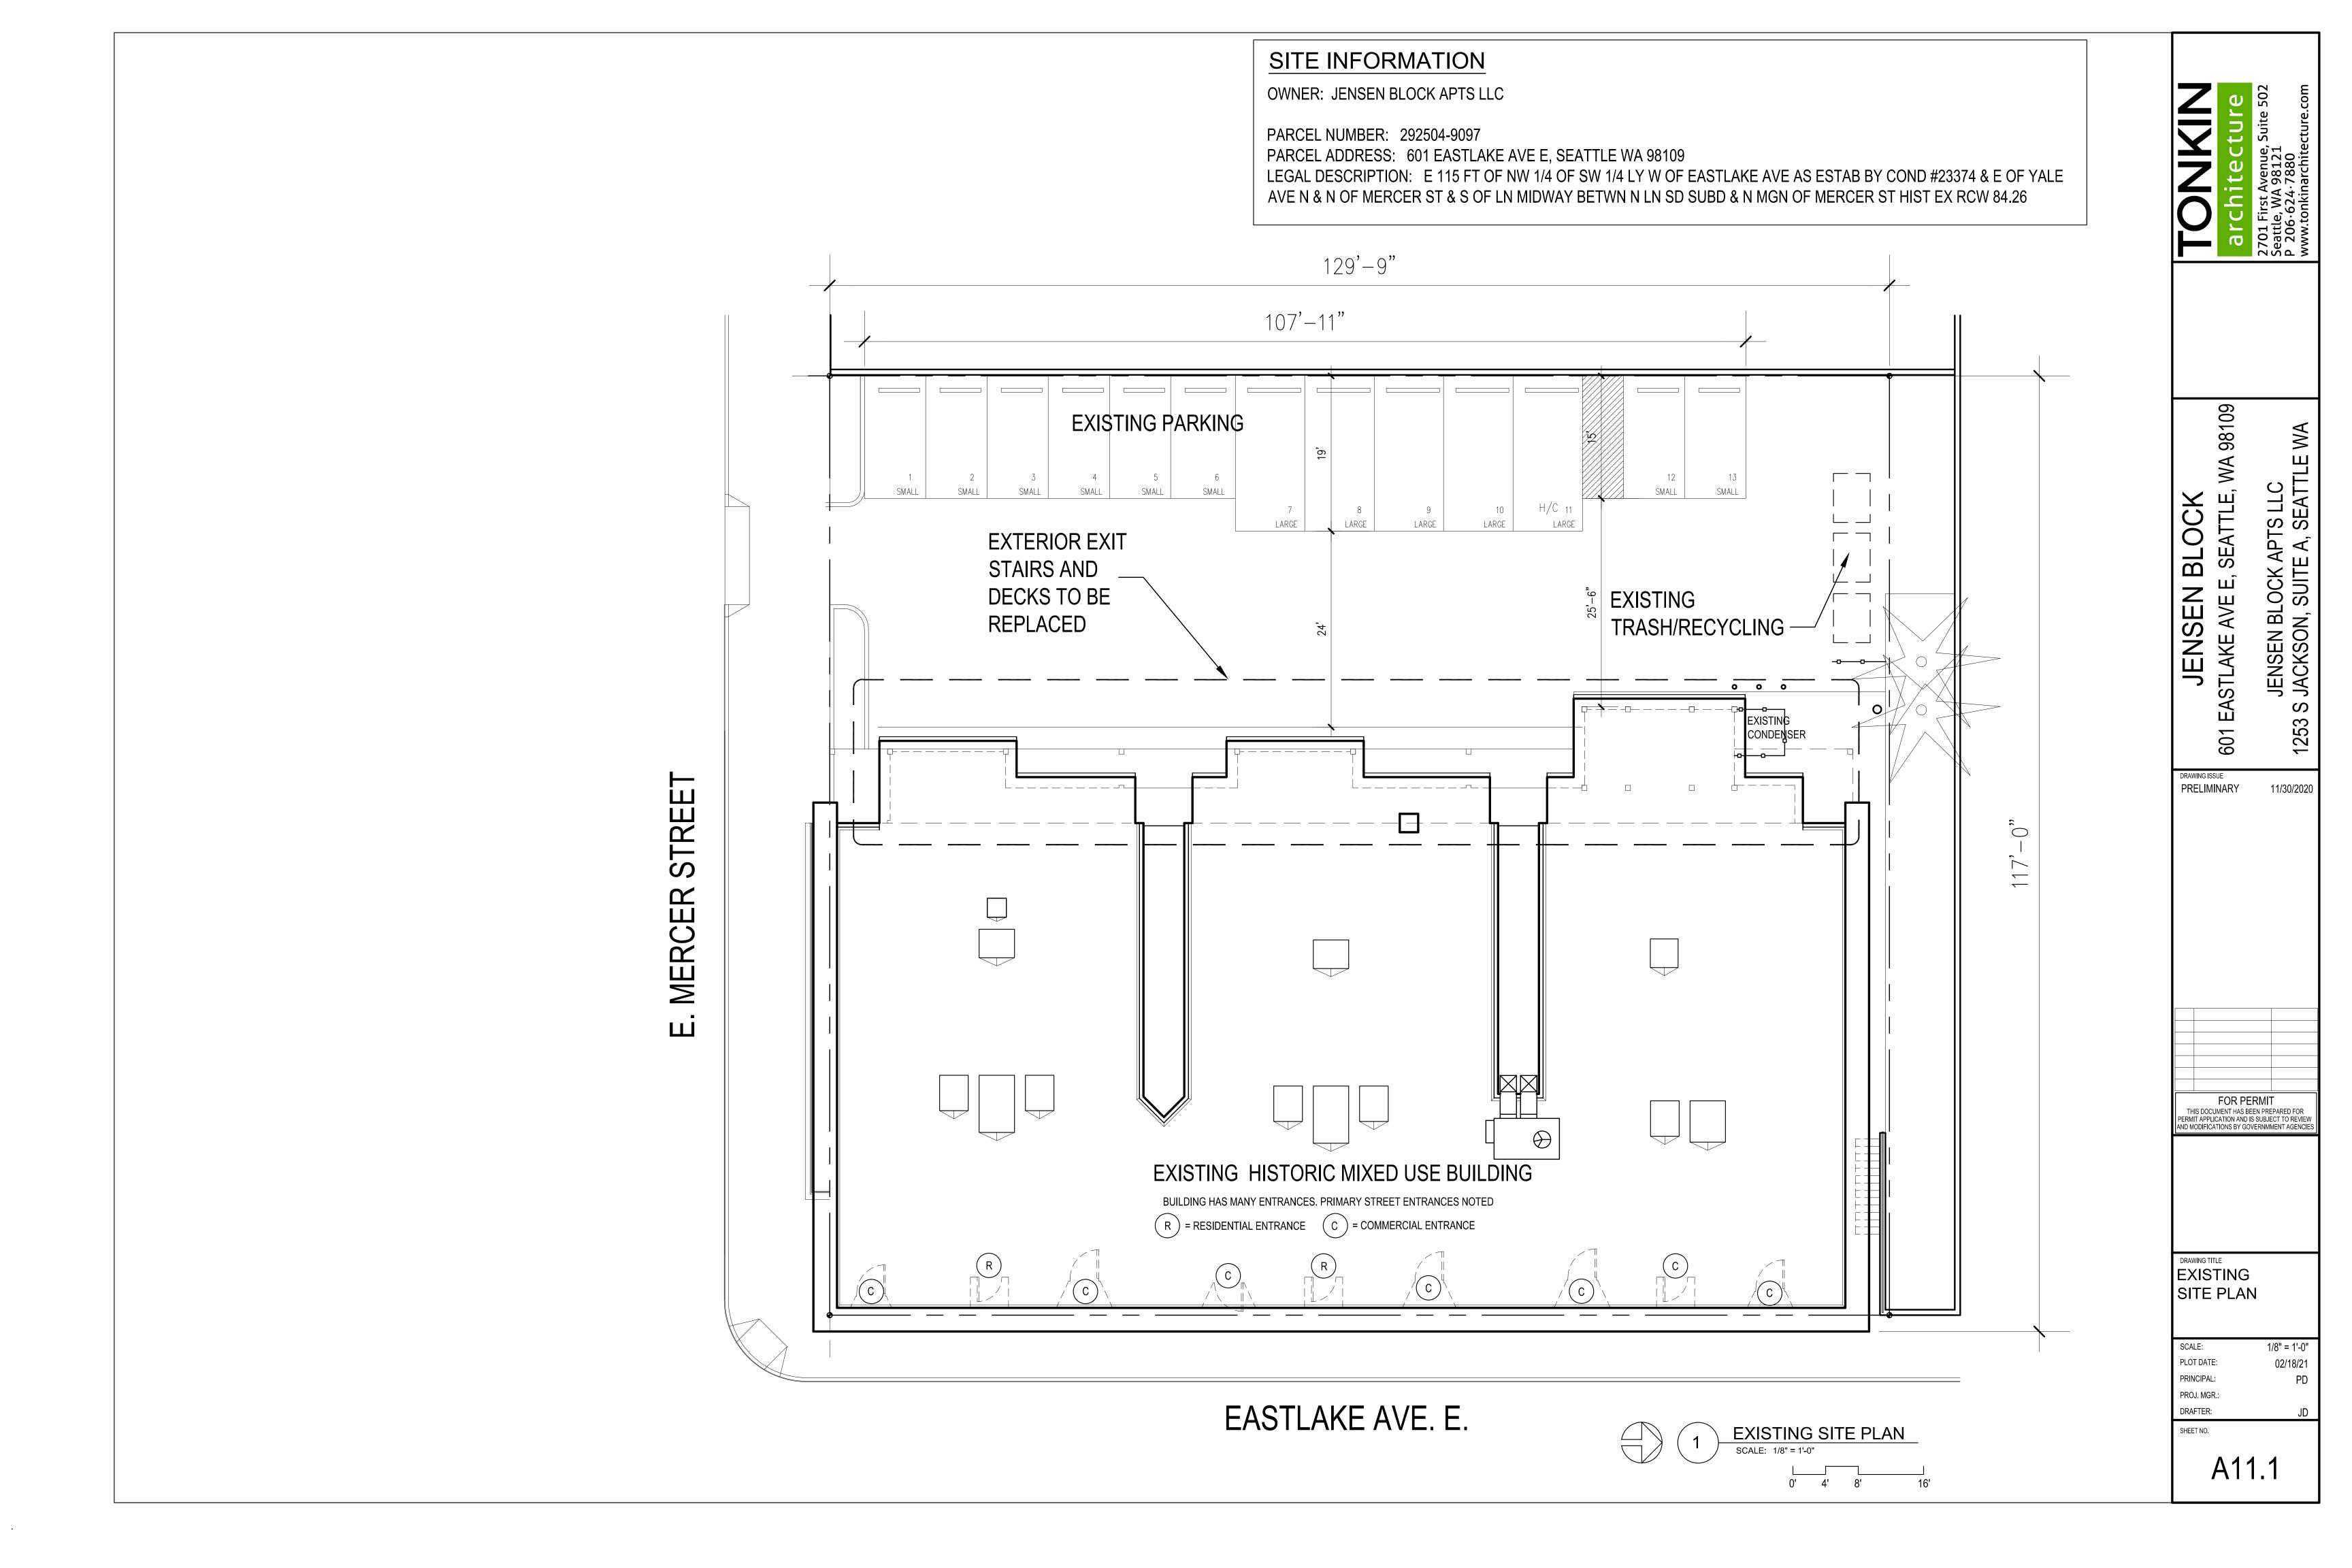
COVER SHEET


As indicated PLOT DATE: 02/18/21 PRINCIPAL:


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JENSEN BLOCK 601 EASTLAKE AVE E, SEATTLE, WA 98109 JENSEN BLOCK APTS LLC 1253 S JACKSON, SUITE A, SEATTLE WA DRAWING ISSUE
PRELIMINARY
LANDMARKS 11/30/2020 02/18/2021 REV FOR PERMIT

THIS DOCUMENT HAS BEEN PREPARED FOR PERMIT APPLICATION AND IS SUBJECT TO REVIEW AND MODIFICATIONS BY GOVERNMMENT AGENCIES SDCI DEDICATED **APPROVAL STAMP SPACE** EXISTING PARKING & STAIRS
BASEMENT PLAN



EXISTING PARKING & STAIRS BASEMENT PLAN

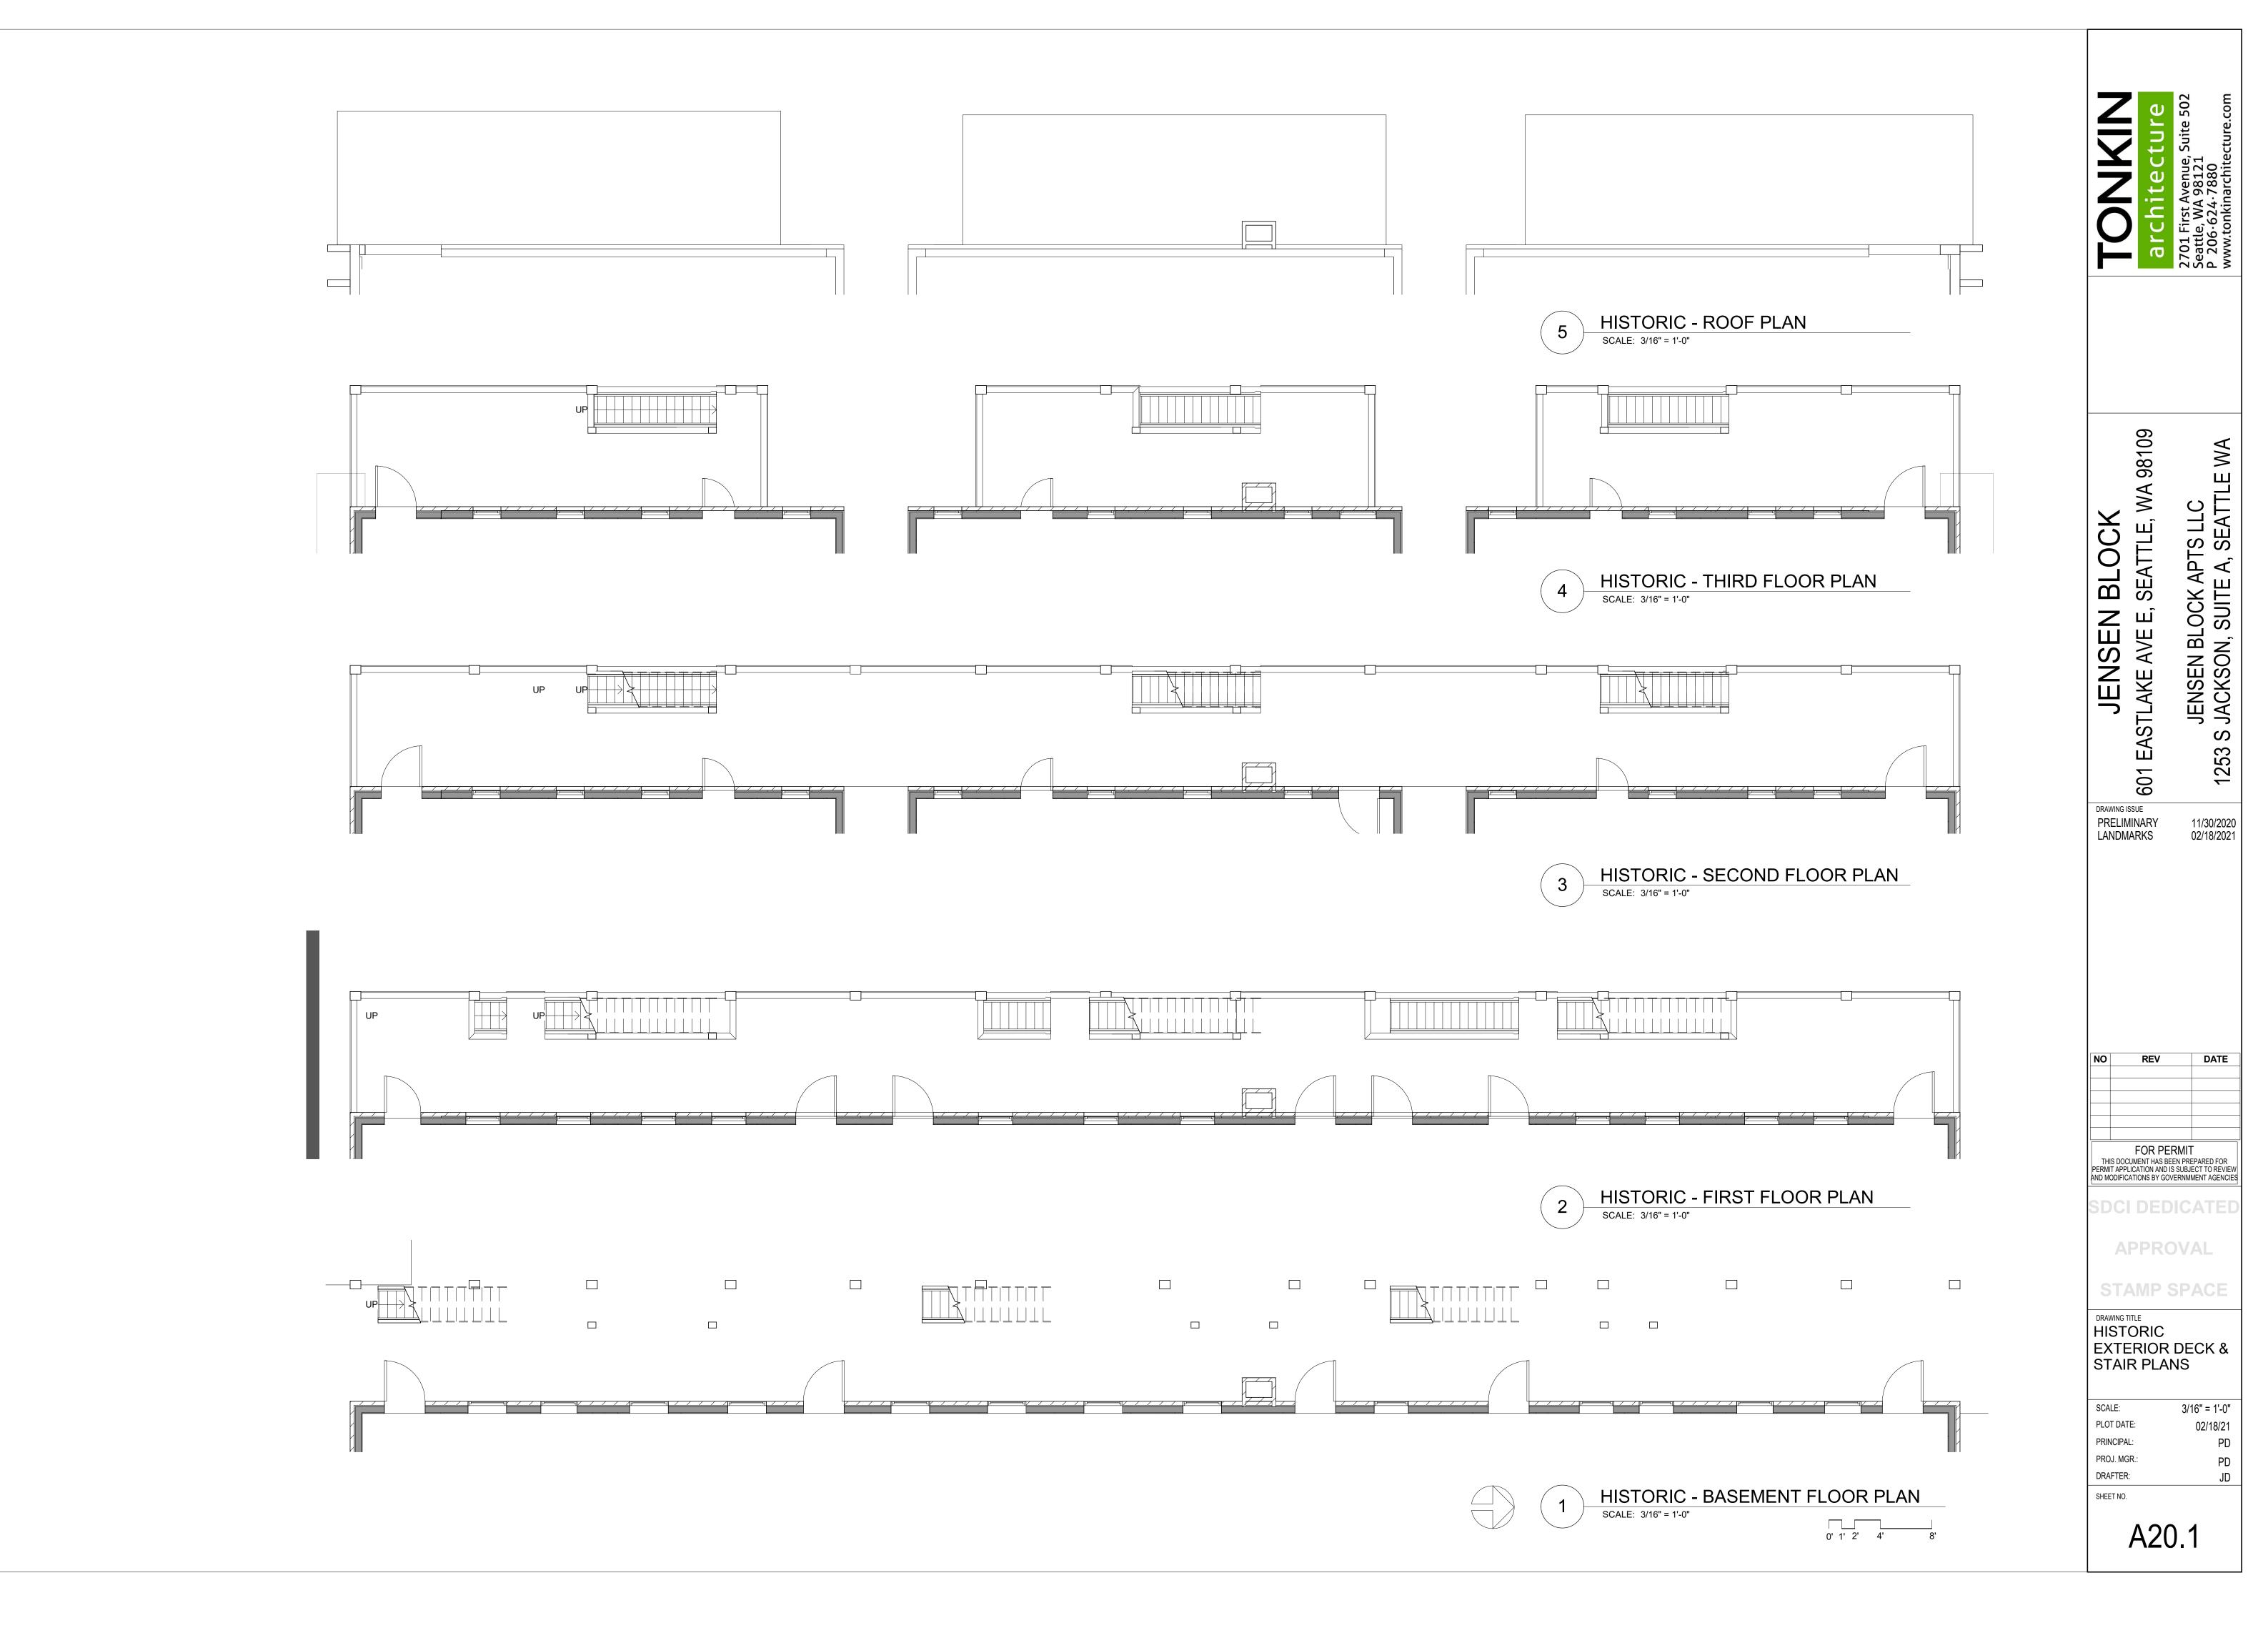SCALE: 3/16" = 1'-0"

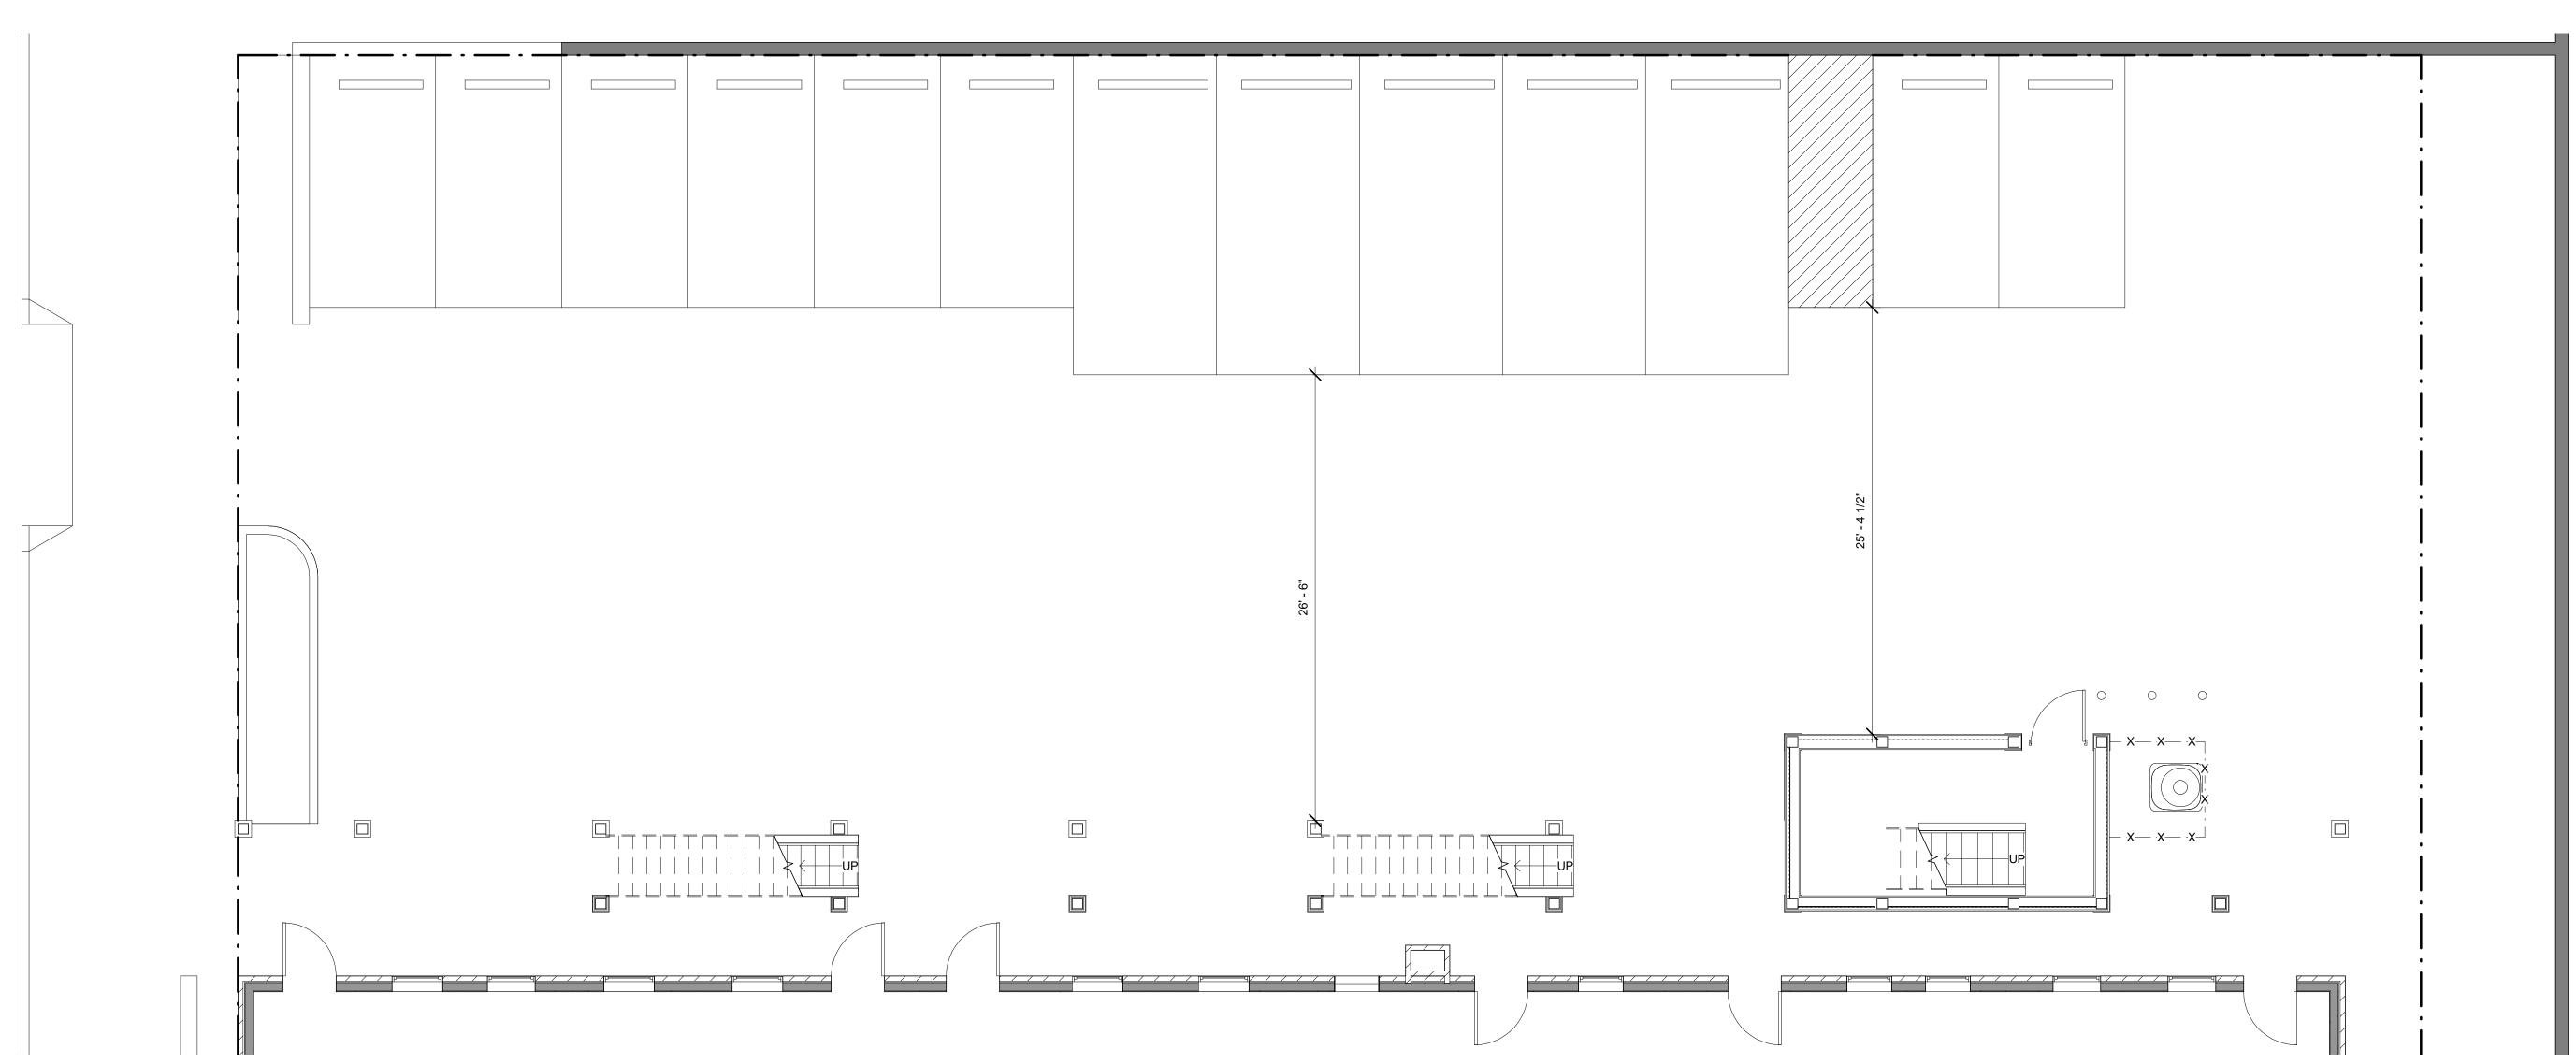0' 1' 2' 4' 8'

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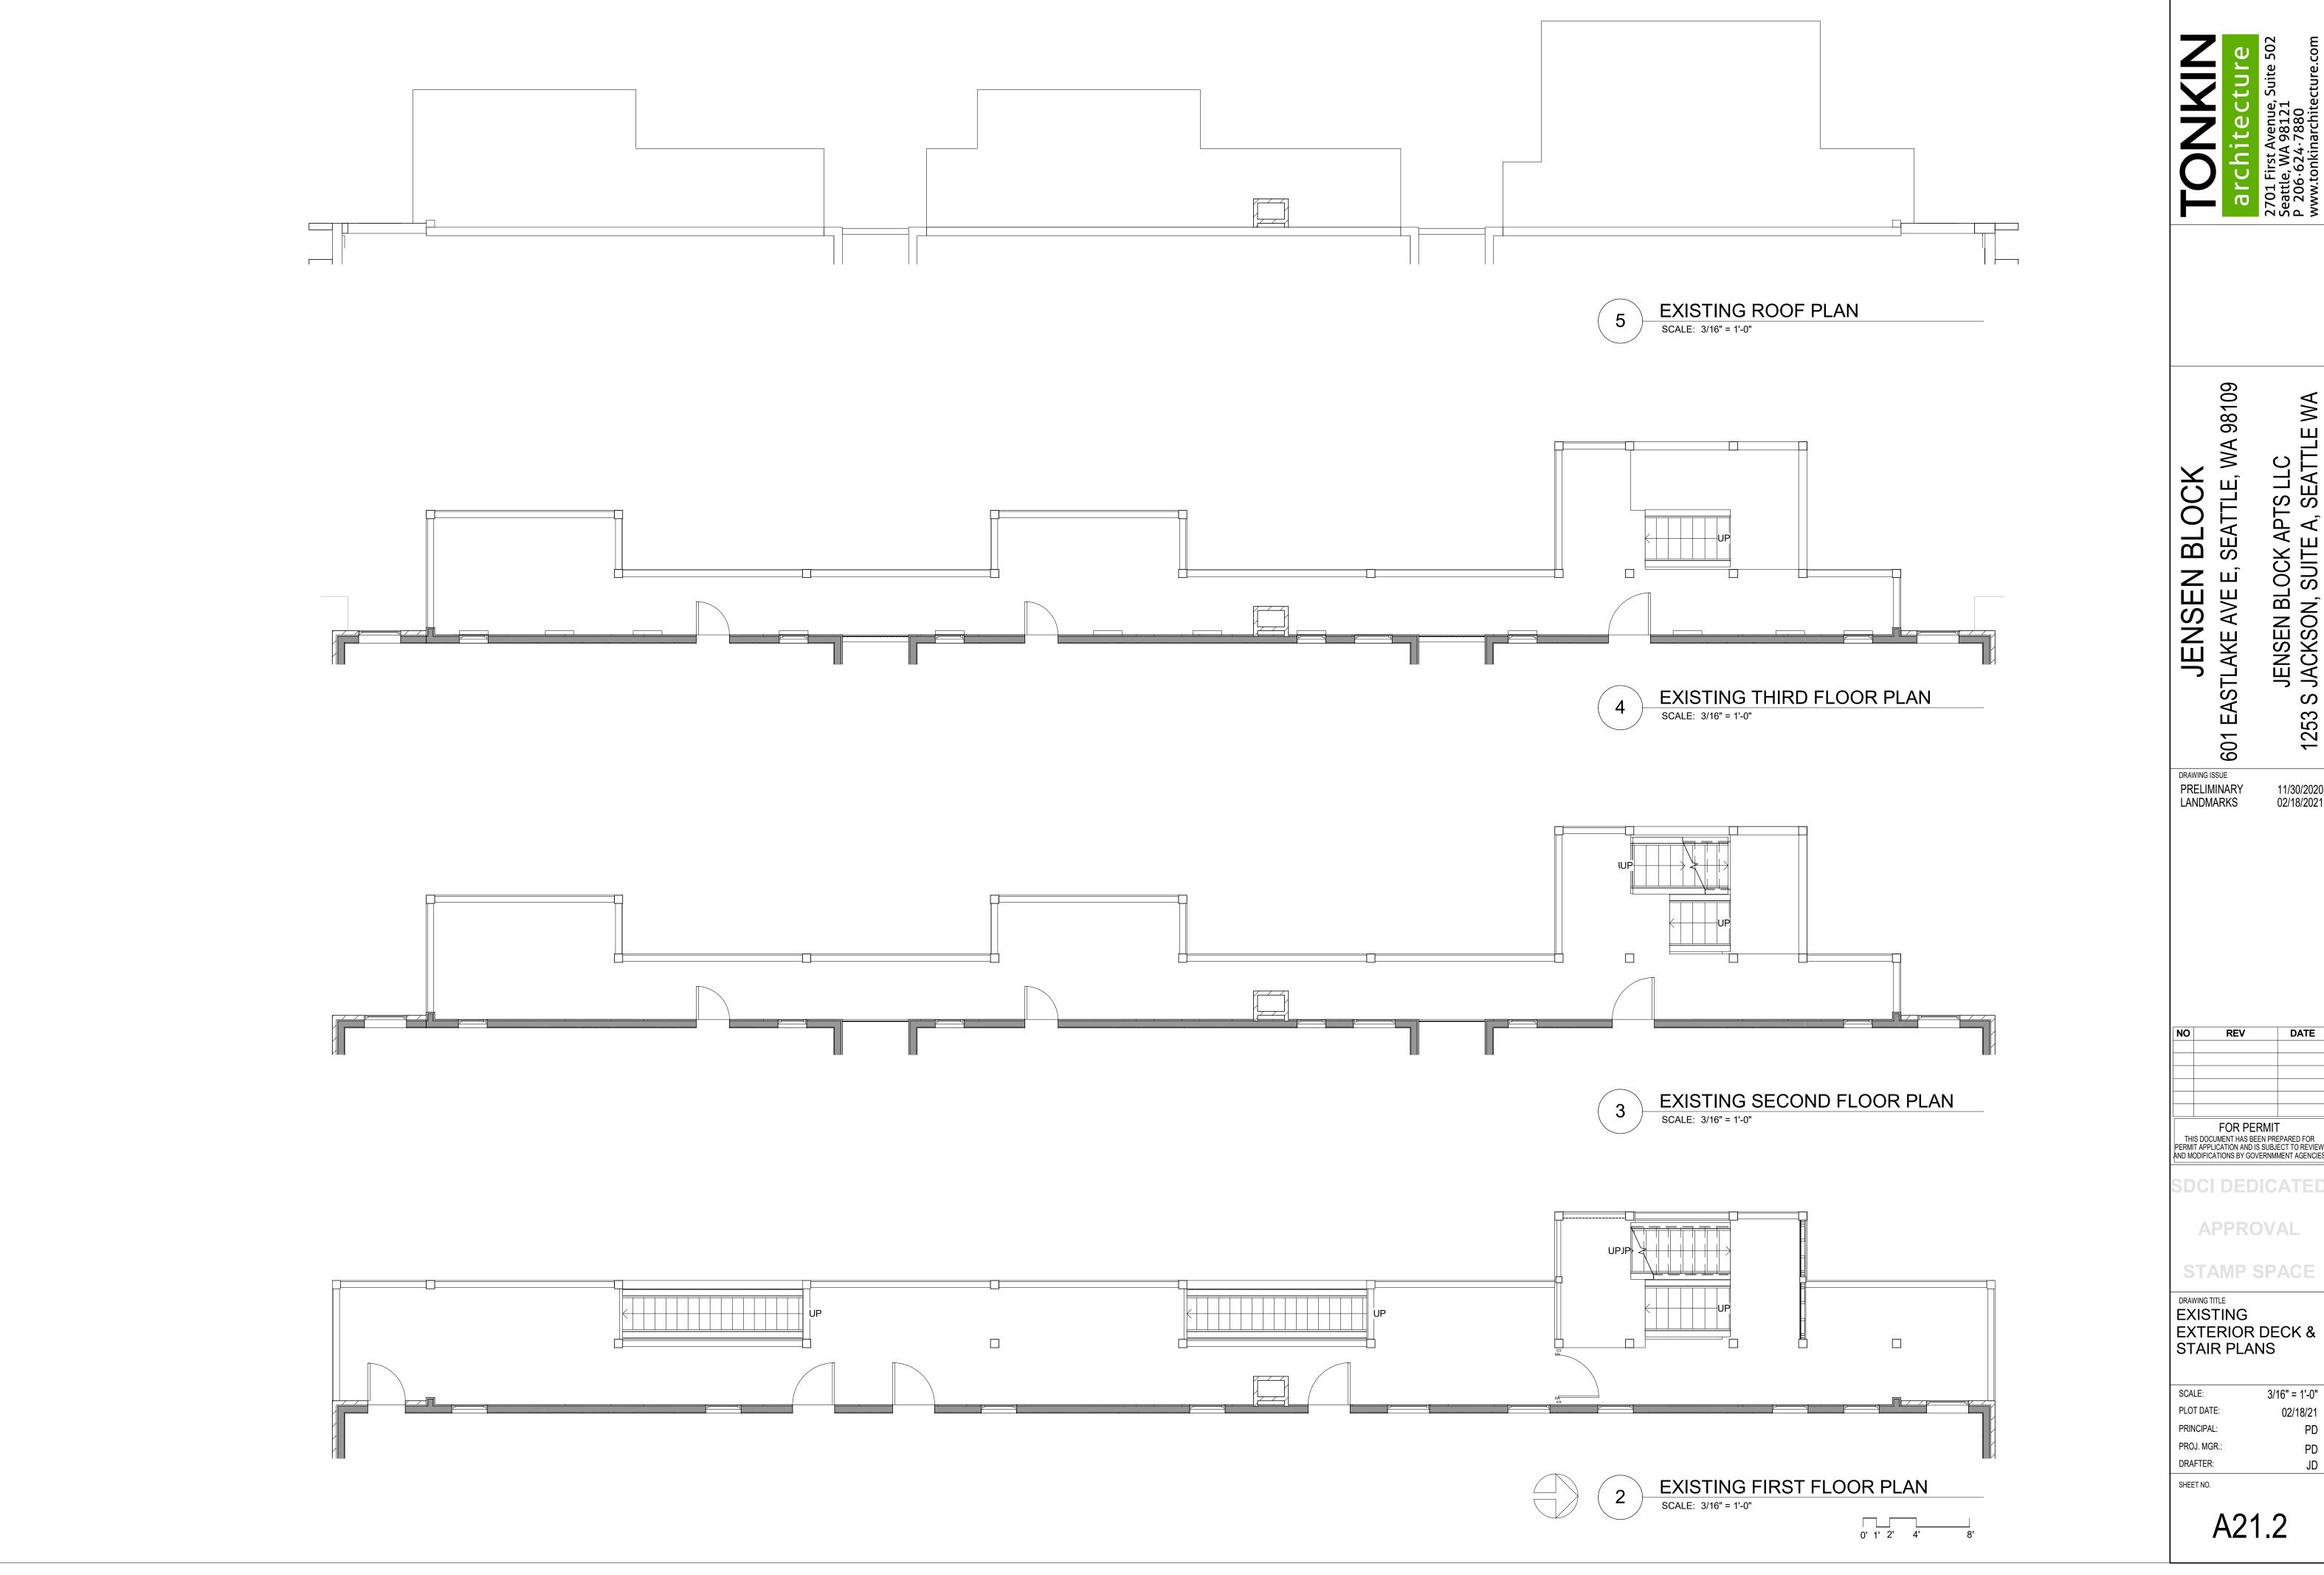
SCALE:

PLOT DATE:

PRINCIPAL: PROJ. MGR.:

A21.1

3/16" = 1'-0"



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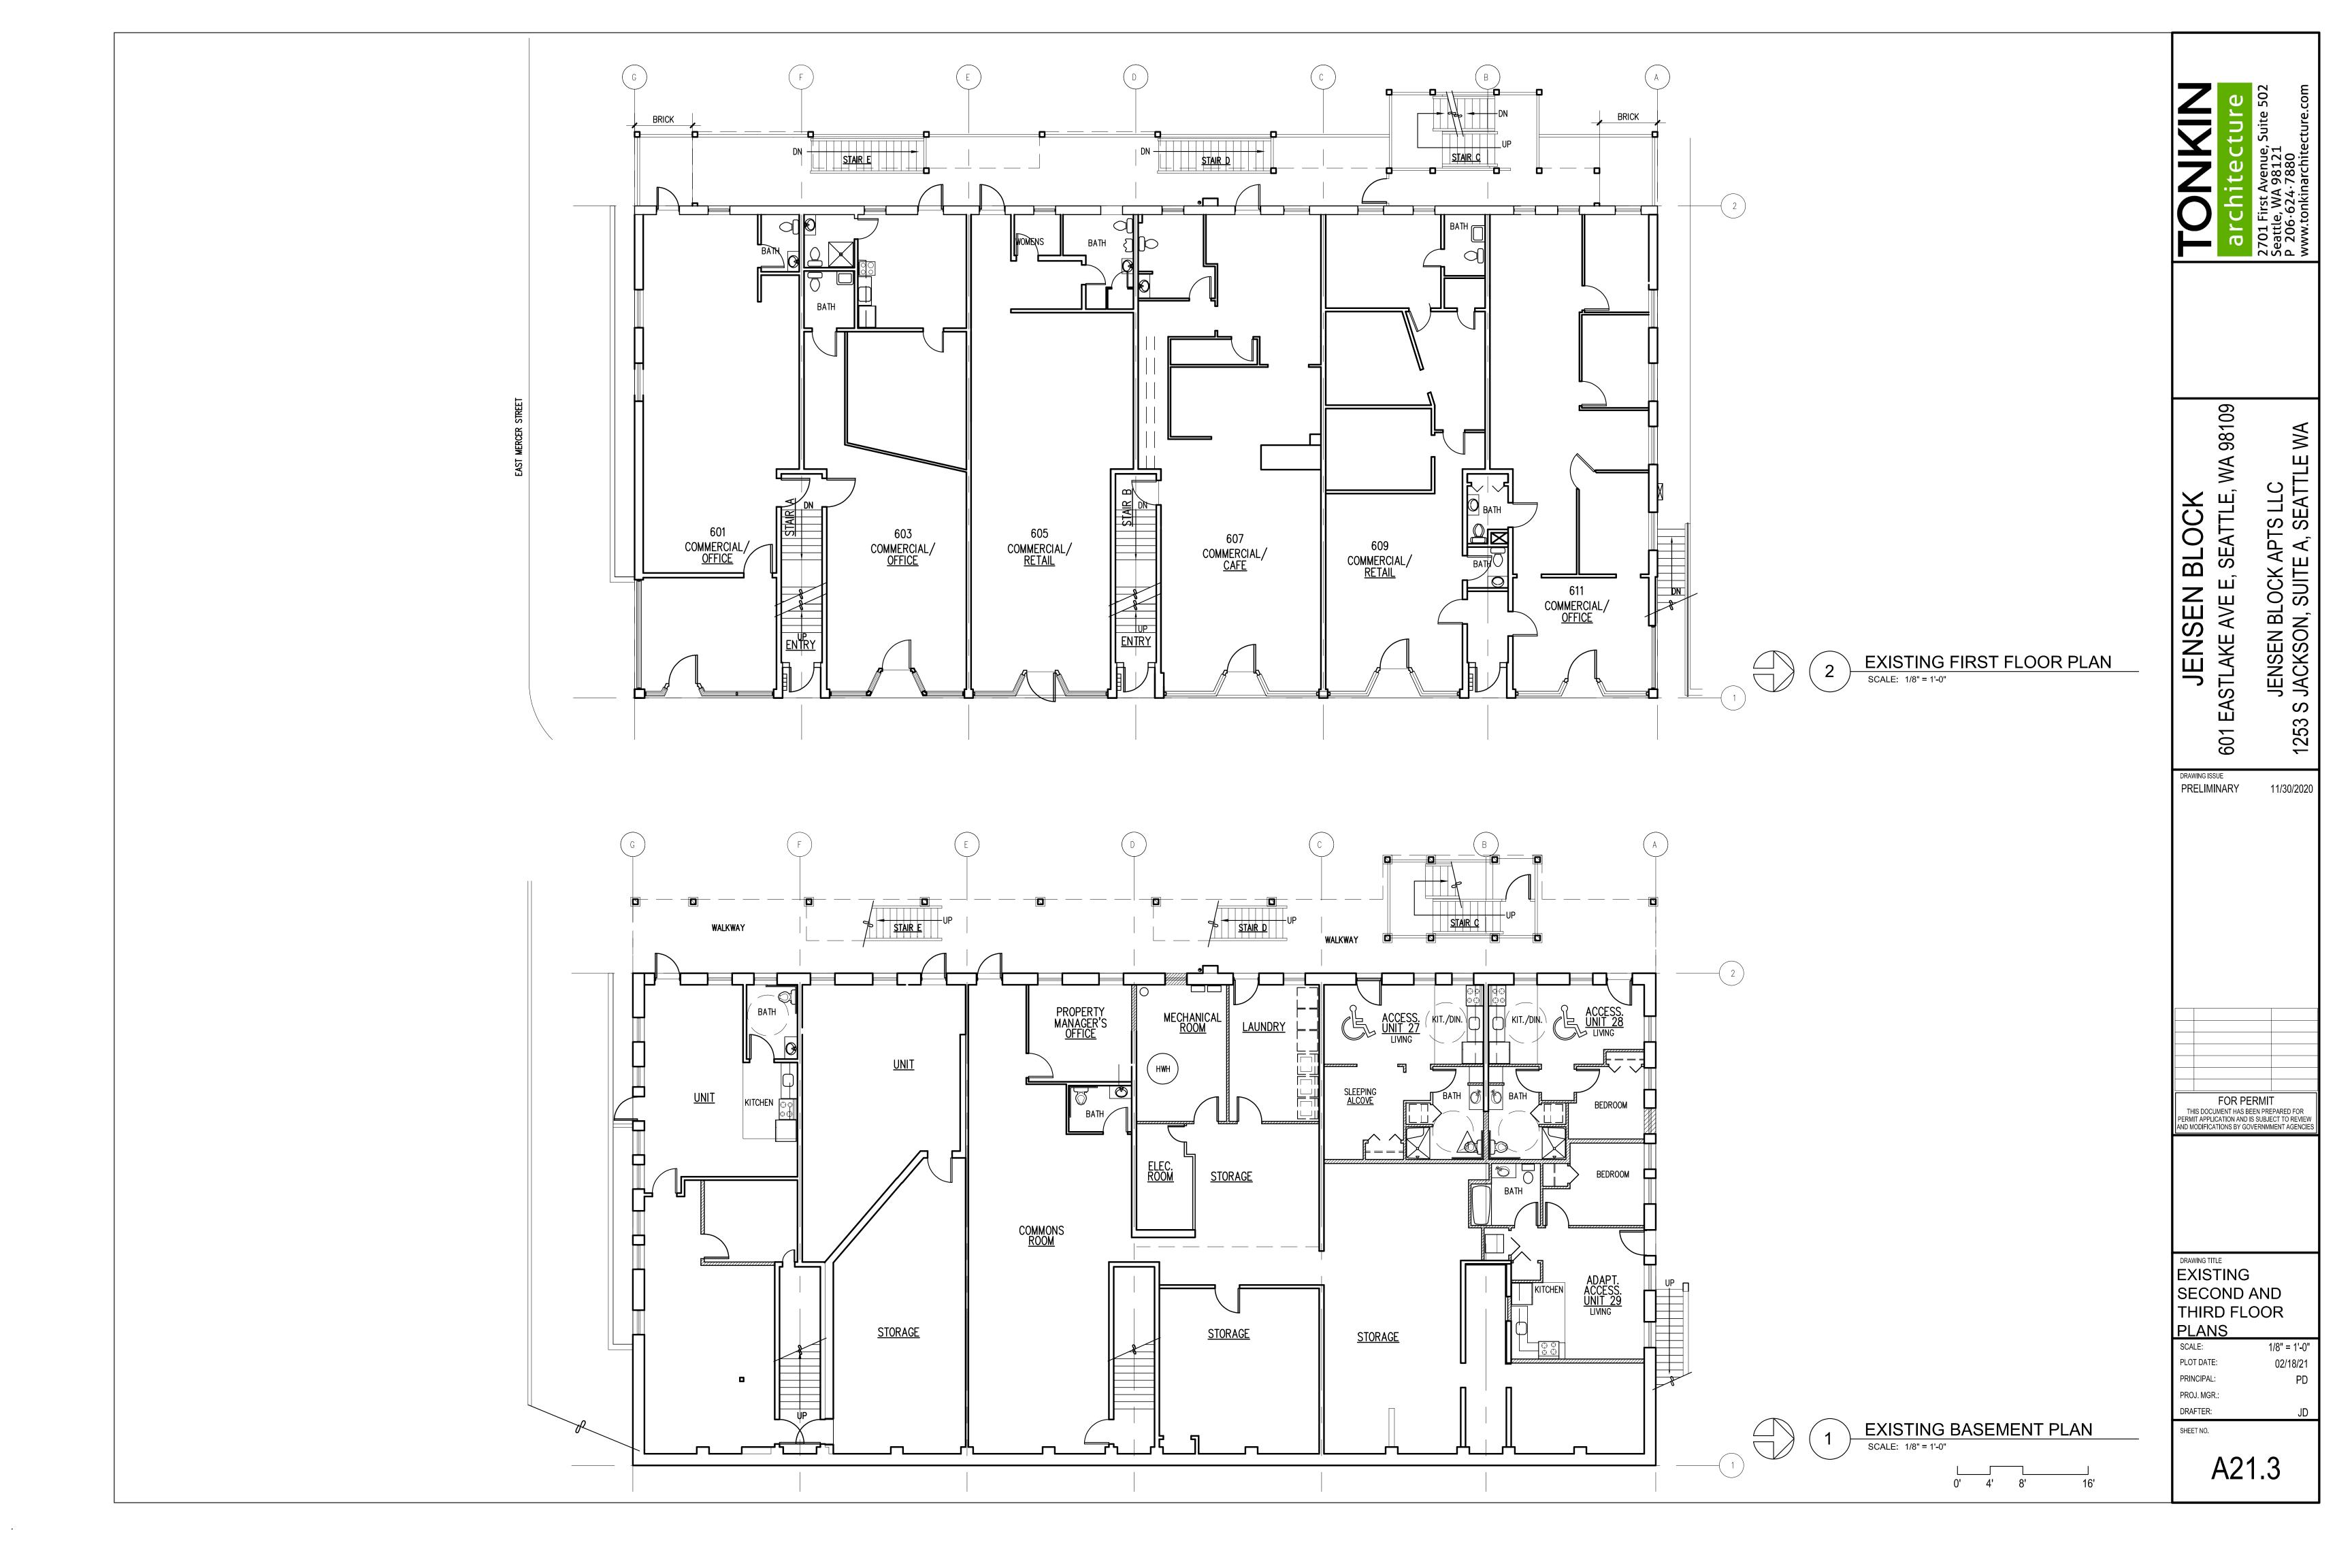
APPROVAL


STAMP SPACE DRAWING TITLE

EXISTING EXTERIOR DECK & STAIR PLANS

3/16" = 1'-0" PLOT DATE: 02/18/21 PRINCIPAL: PROJ. MGR.:

A21.2




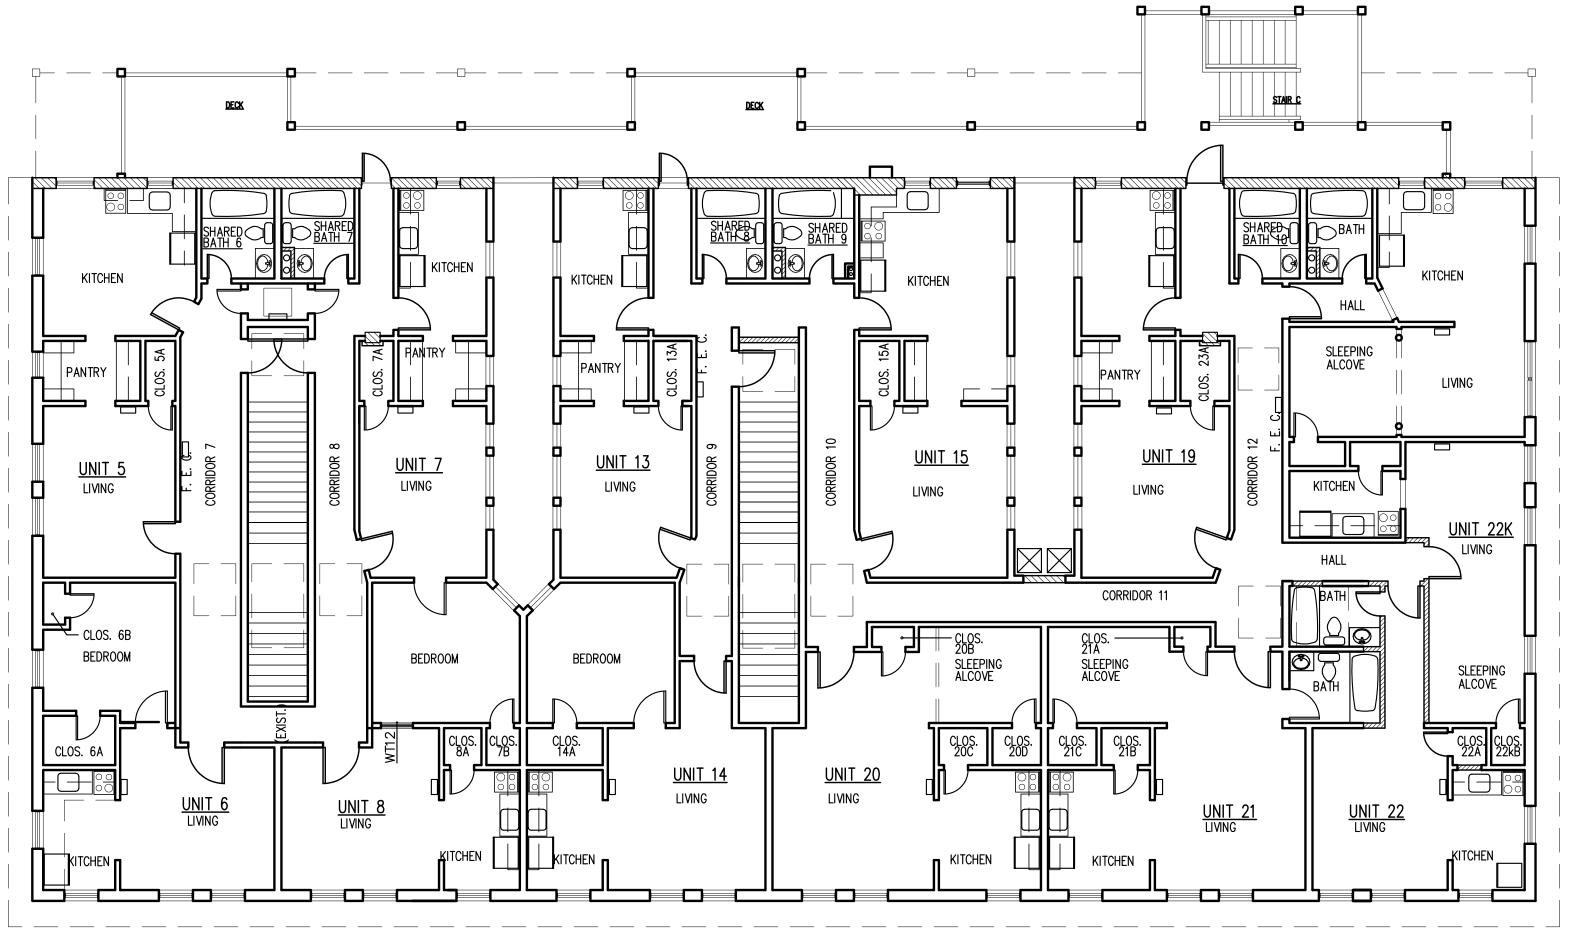

2 EXISTING THIRD FLOOR PLAN

SCALE: 1/8" = 1'-0"

EXISTING SECOND FLOOR PLAN

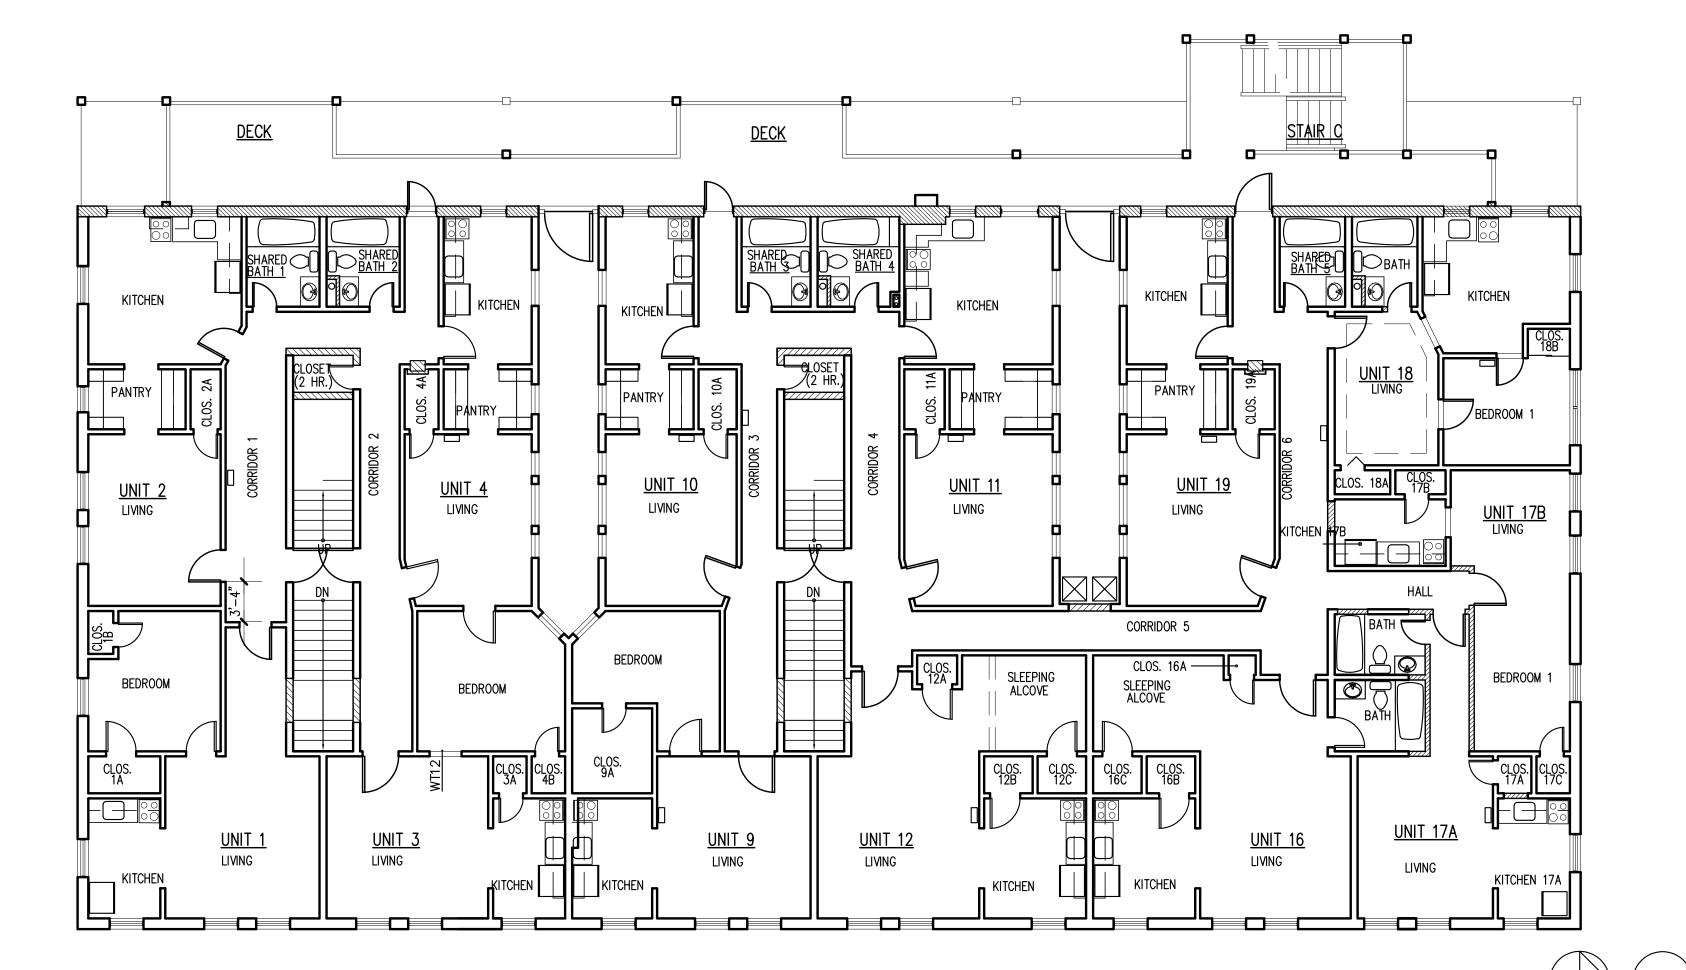

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JENSEN BLOCK APTS LLC
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EXISTING
SECOND AND
THIRD FLOOR
PLANS


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A21.4

1/8" = 1'-0"

02/18/21



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STAMP SPACE

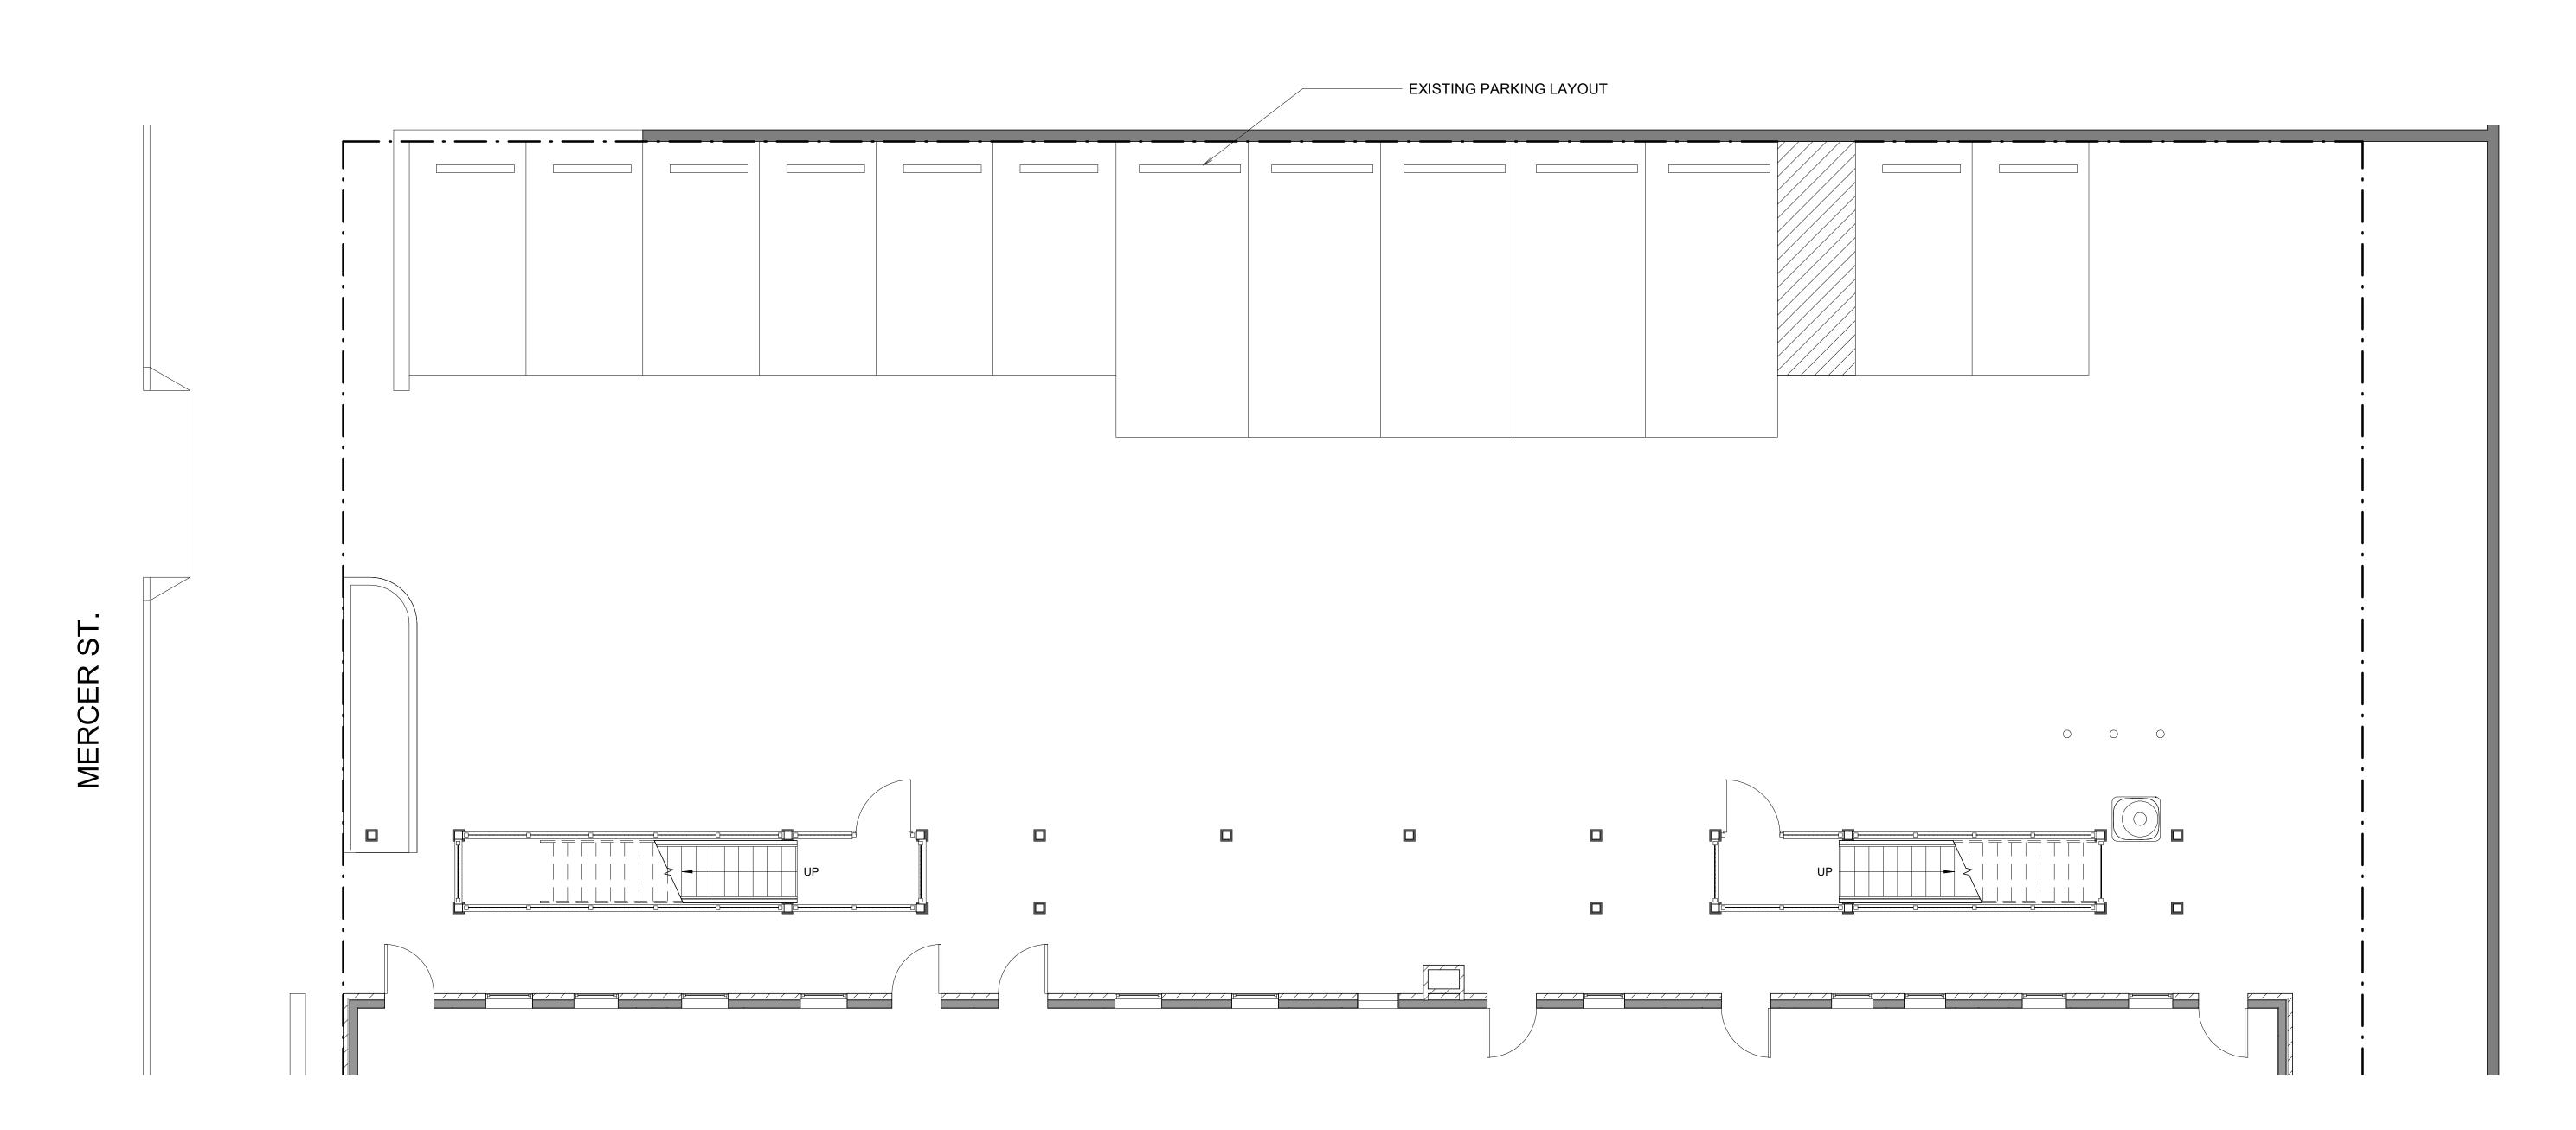DRAWING TITLE PROPOSED PARKING & STAIRS
BASEMENT PLAN

SCALE: 3/16" = 1'-0" PLOT DATE: 02/18/21 PRINCIPAL: PROJ. MGR.: DRAFTER:


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PARKING AND BASEMENT LEVEL PLAN

SCALE: 3/16" = 1'-0"

0' 1' 2' 4' 8'

A22.1

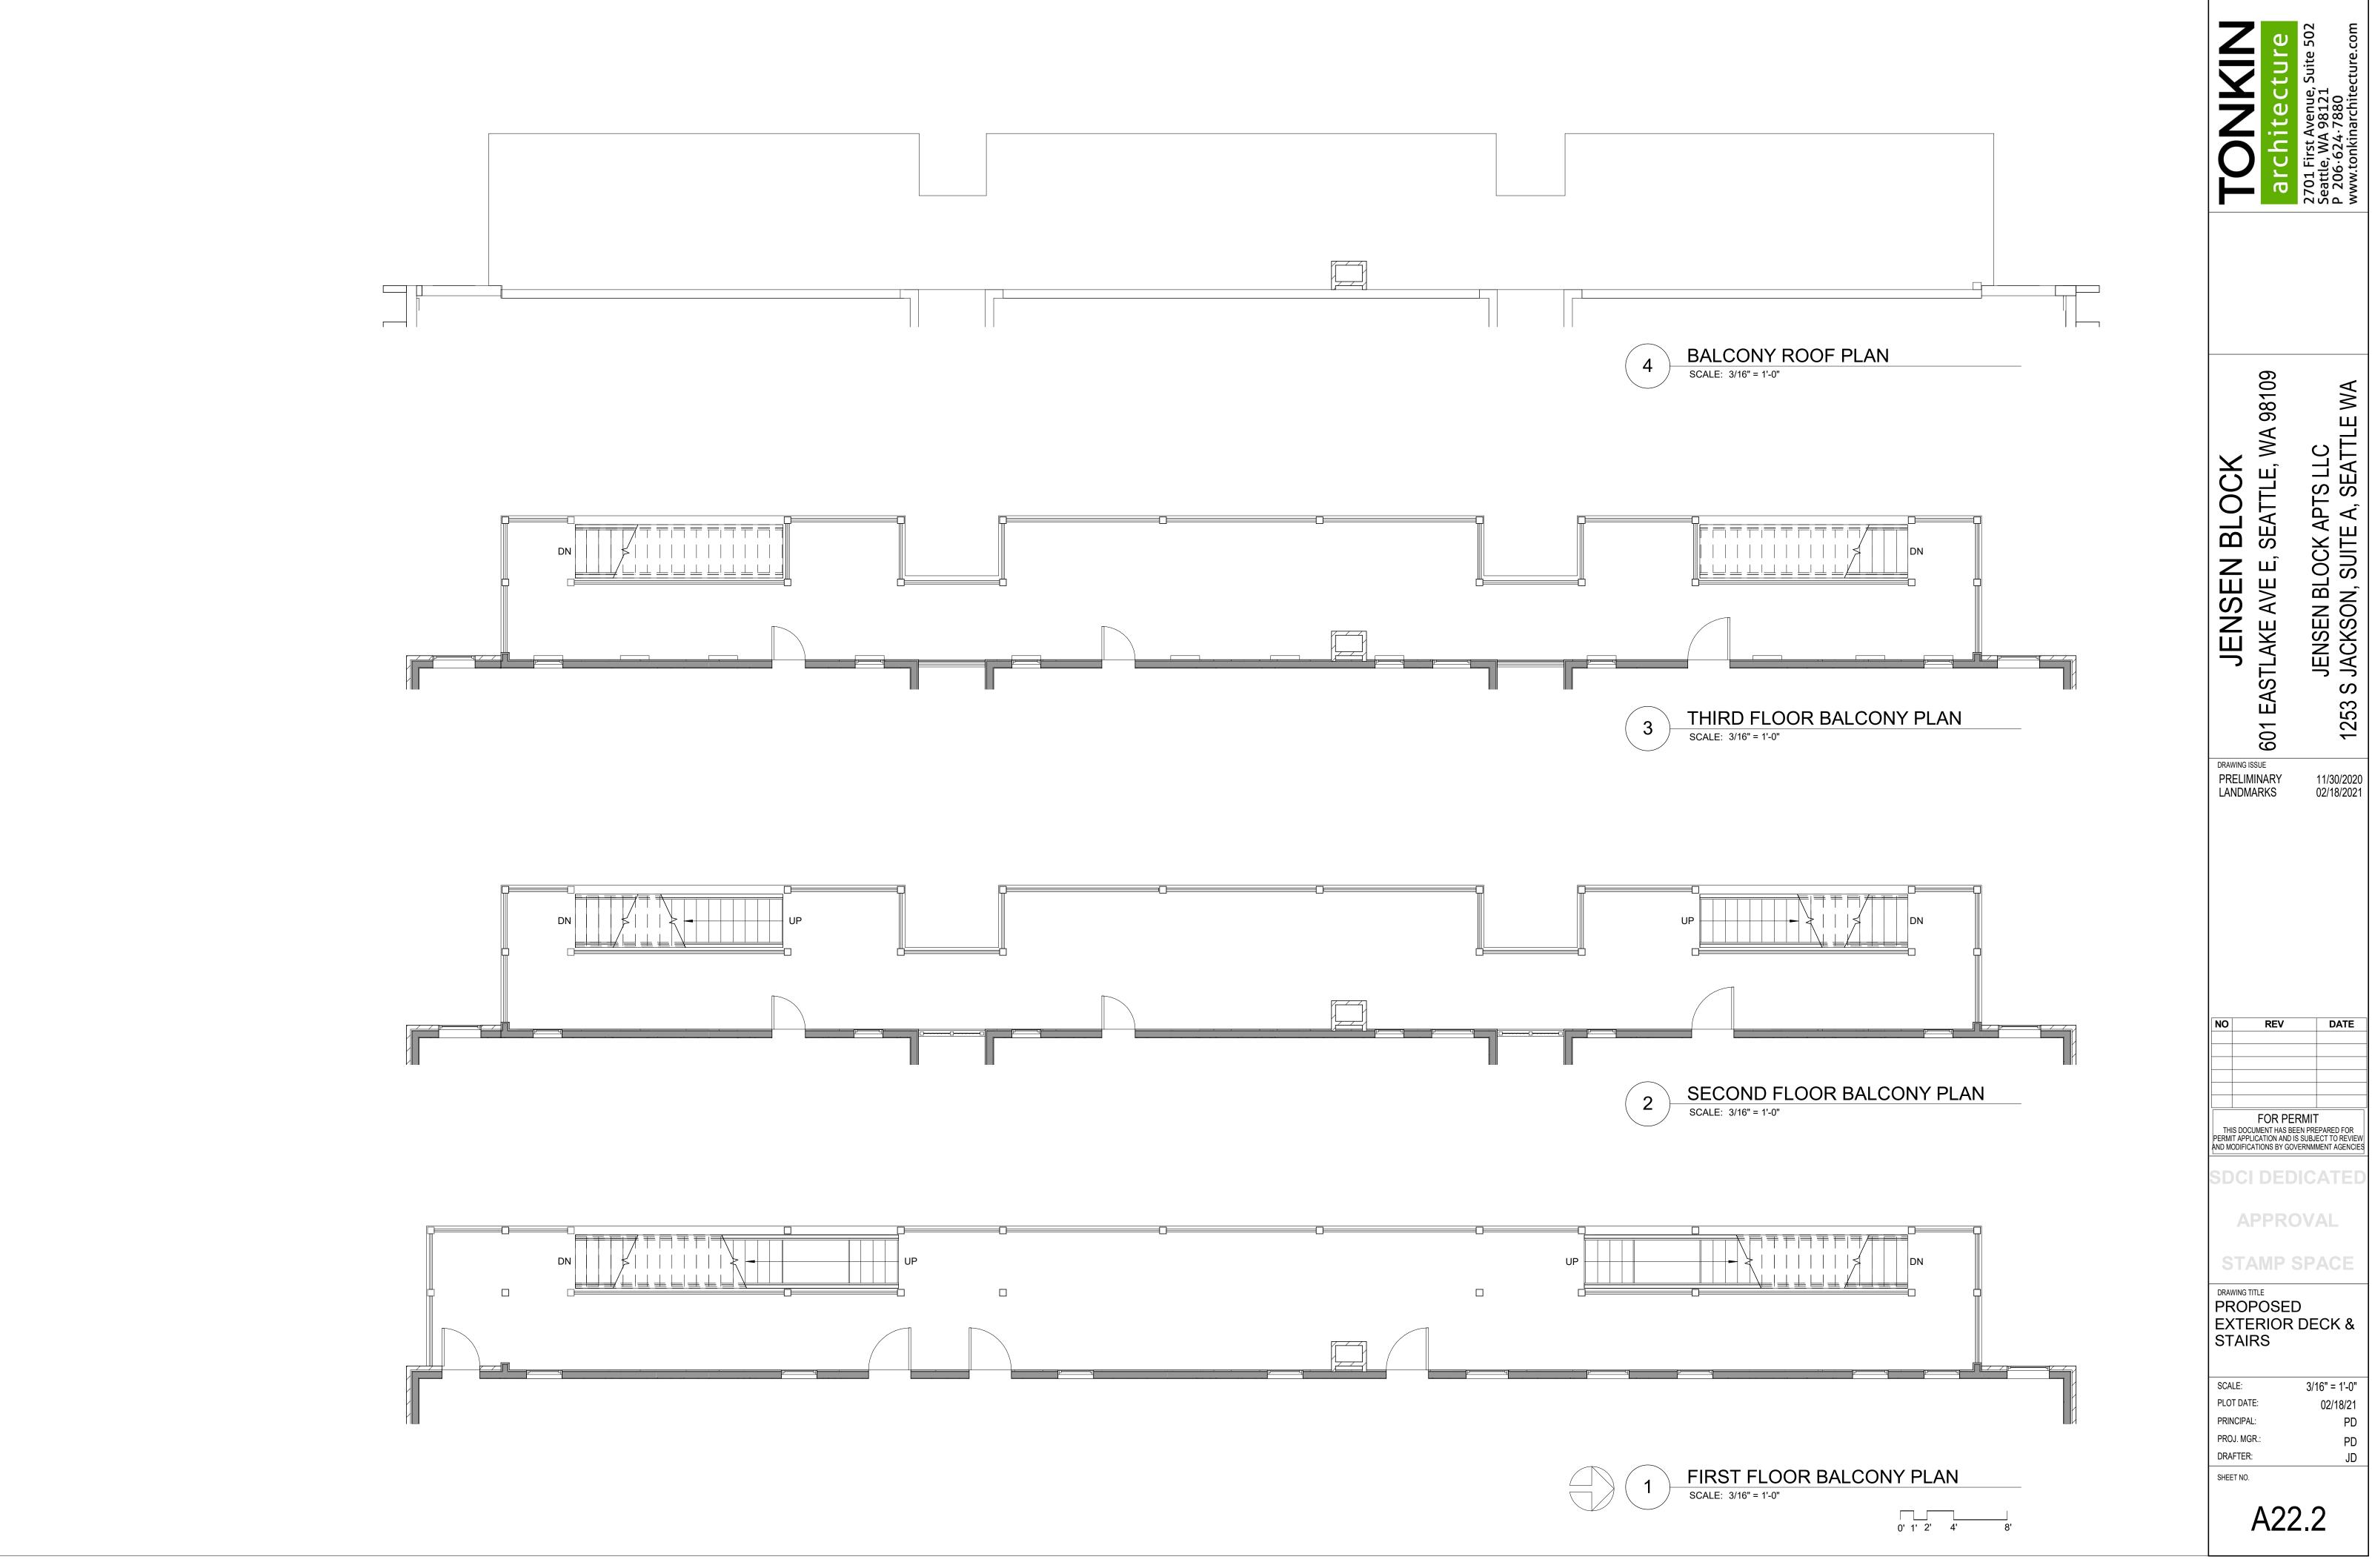


DATE

3/16" = 1'-0" 02/18/21



2 EXISTING - WEST ELEVATION

SCALE: 1/8" = 1'-0"

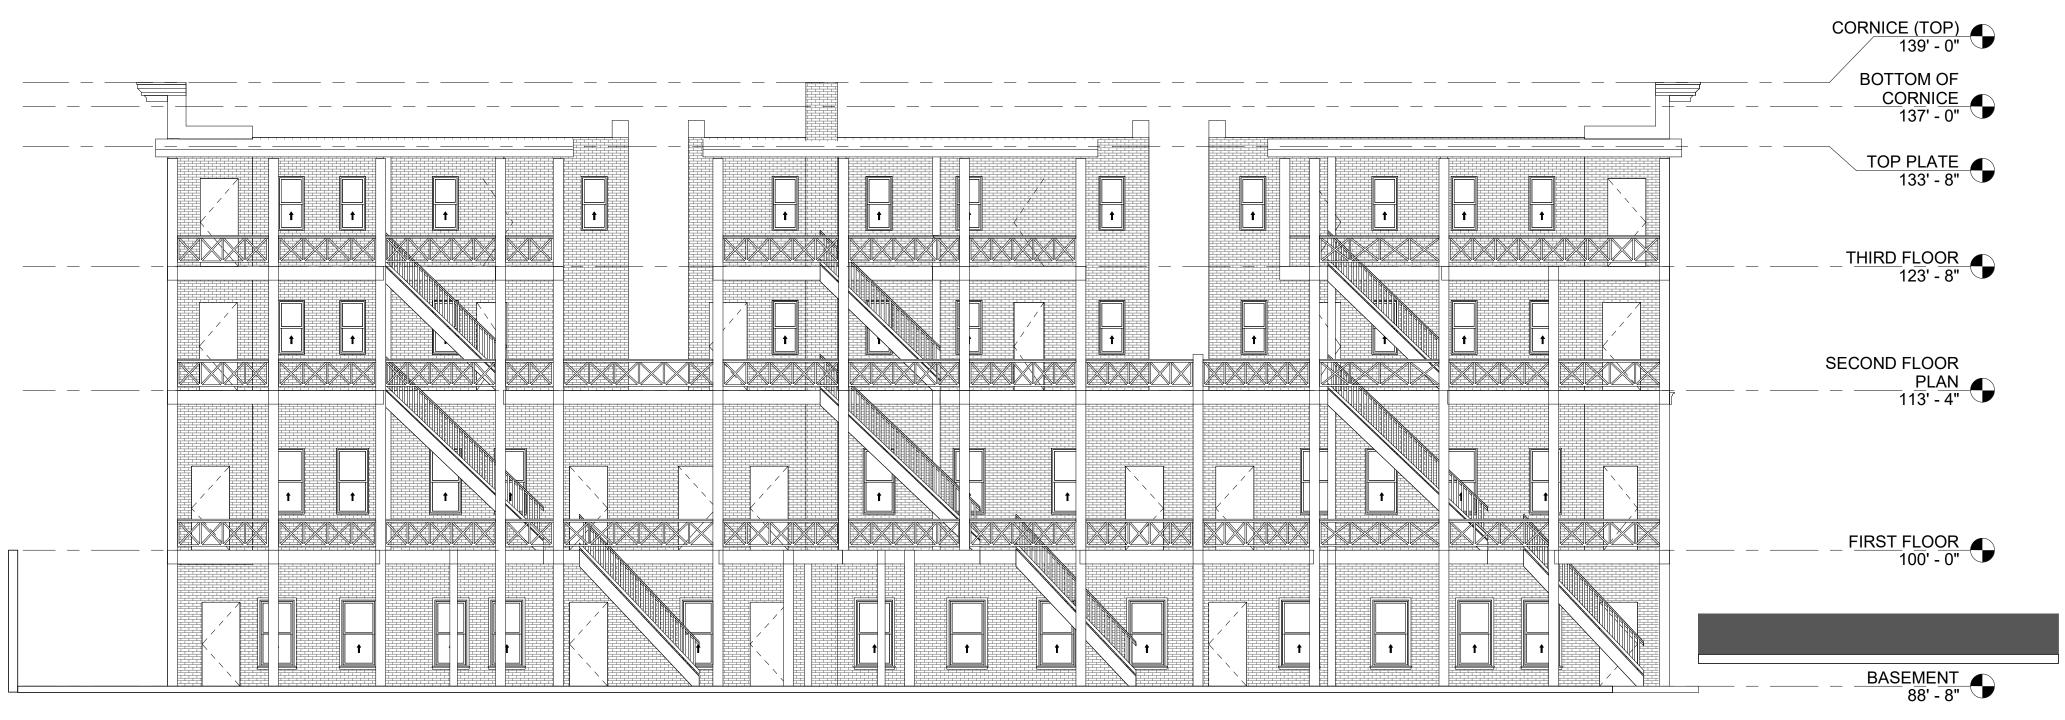

1 HISTORIC - WEST ELEVATION

SCALE: 1/8" = 1'-0"

TONKIN 2701 First Avenue, Suite 5 Seattle, WA 98121 P 206·624·7880 www.tonkinarchitecture.c 601 EASTLAKE AVE E, SEATTLE, WA 98109 JENSEN BLOCK APTS LLC 1253 S JACKSON, SUITE A, SEATTLE WA JENSEN BLOCK PRELIMINARY LANDMARKS 11/30/2020 02/18/2021 REV FOR PERMIT

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DRAWING TITLE
WEST ELEVATION HISTORIC &
EXISTING

 SCALE:
 1/8" = 1'-0"

 PLOT DATE:
 02/18/21

 PRINCIPAL:
 PD

 PROJ. MGR.:
 PD

 DRAFTER:
 JD

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1 WEST ELEVATION - PROPOSED

SCALE: 1/8" = 1'-0"

TOTAL PROPOSED DECK AREA -TOTAL PROPOSED RAILING LENGTH -TOTAL NUMBER OF POSTS -TOTAL STRUCTURE HEIGHT -

3,090 SF 455'-6" _____ 24 0 45'-0" '

4' 8' 16' 24'

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DRAWING TITLE
WEST
ELEVATION
PROPOSED

SCALE:

1/8" = 1'-0"

JENSEN BLOCK EASTLAKE AVE E, SEATTLE, WA 98109

601

JENSEN BLOCK APTS LLC JACKSON, SUITE A, SEATTLE WA

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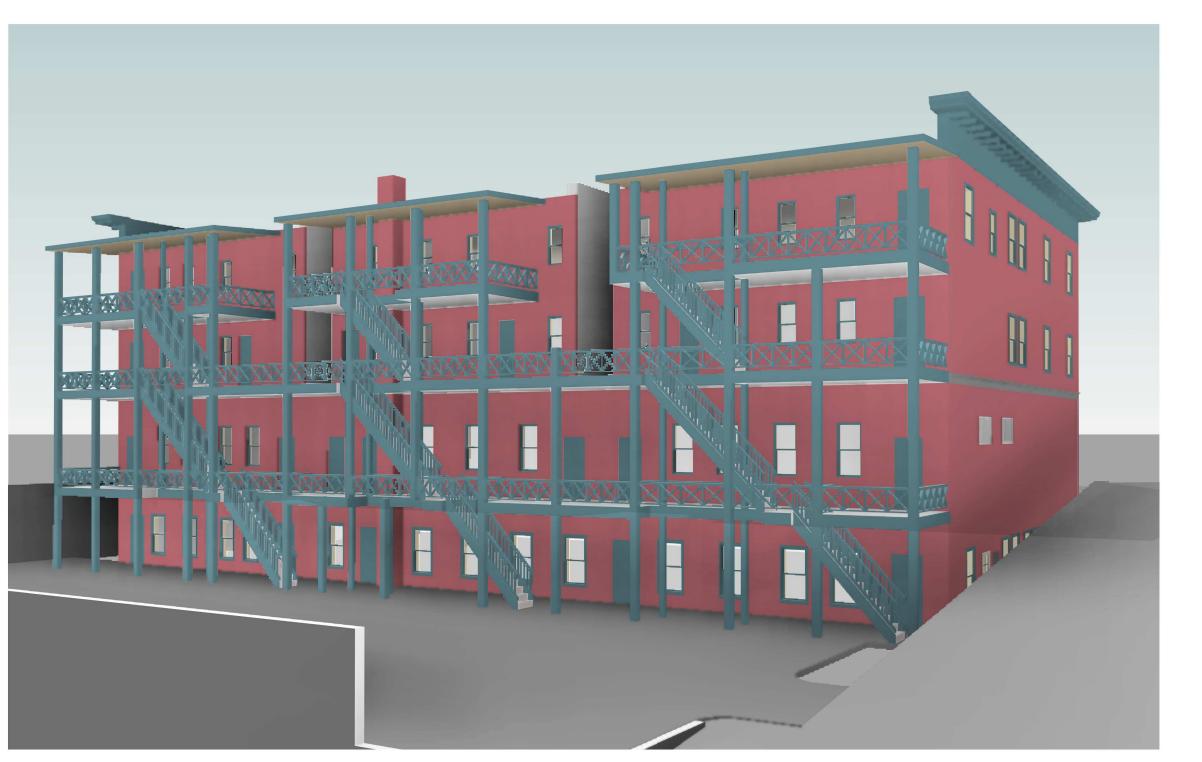




2 HISTORIC - CORNER VIEW
SCALE: NTS



3 EXISTING - STREET VIEW
SCALE: NTS



1 HISTORIC - STREET VIEW
SCALE: NTS

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APPROVAL
STAMP SPACE

PERSPECTIVE
VIEWS - HISTORIC
AND EXISTING

SCALE:

PLOT DATE: 02/18/21

PRINCIPAL: PD

PROJ. MGR.: PD


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PROPOSED - STREET VIEW SCALE: NTS

PROPOSED MATERIALS AND ASSEMBLIES

STRUCTURE -DECK -STAIRS -SECURITY ENCLUSURES -STEEL PROTECTED WITH INTUMESCENT PAINT AND PAINTED TO MATCH EXISTING CORNICE CONCRETE DECK ON STEEL (1HR FIRE RATED)
STEEL GRATE OR CONCRETE RISERS AND TREADS WITH ALUMINUM RAILINGS PAINTED TO MATCH EXISTING CORNICE STEEL SECURITY MESH

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SDCI DEDICATED **APPROVAL**

STAMP SPACE

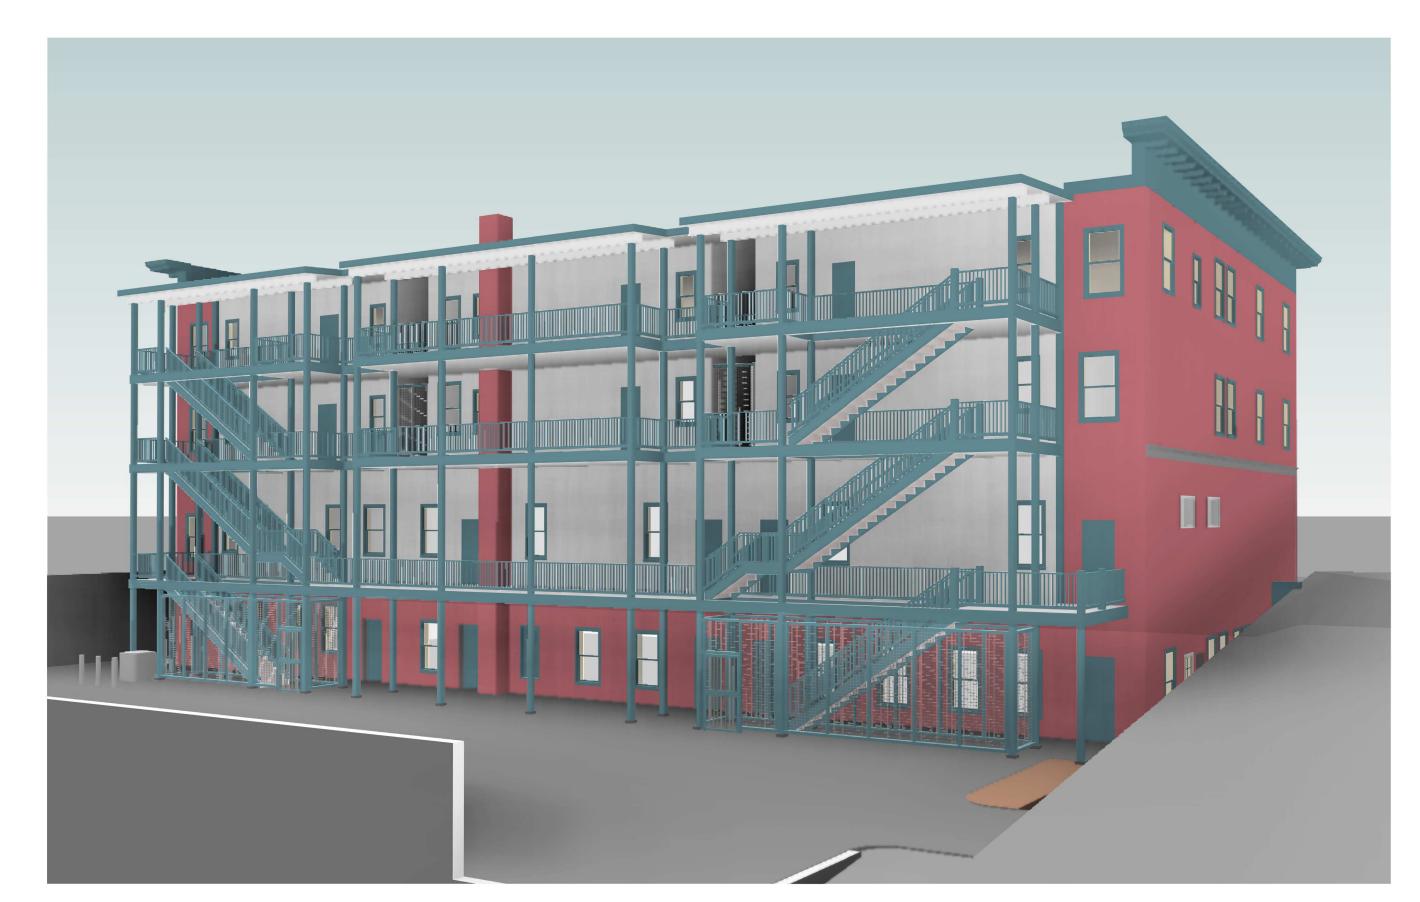PERSPECTIVE VIEWS -PROPOSED

PLOT DATE: PRINCIPAL: PROJ. MGR.: DRAFTER:

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A41.1